

SITE DATA:

APN: 048-014-100, 048-014-110 ZONING: R-1/S-17/DR/CD OCCUPANCY GROUP: R-3/U
TYPE OF CONSTRUCTION: V-B

PLN: BLD:

APPLICABLE CODES: SAN MATEO COUNTY

SAN MATEO COUNTY ZONING & BUILDING ORDINANCES 2022 CALIFORNIA RESIDENTIAL CODE

2022 CALIFORNIA BUILDING CODE 2022 CALIFORNIA MECHANICAL CODE 2022 CALIFORNIA PLUMBING CODE 2022 CALIFORNIA ELECTRICAL CODE 2022 CALIFORNIA ENERGY CODE

2022 CALIFORNIA FIRE CODE
2022 CALIFORNIA GREEN BUILDING STANDARDS CODE
ANY APPLICABLE CITY CODES, ORDINANCES, OR AMENDMENTS
TO THE CALIFORNIA BUILDING CODE

OWNER: JAVIER MERCADO 461 VISTA RIDGE DRIVE MILPITAS, CA 95035 408-591-0305

mercadoenterprises57@gmail.com

ARCHITECT: EDWARD C LOVE, ARCHITECT 720 MILL ST HALF MOON BAY, CA 94019 650-728-7615 edwardclovearch@gmail.com

STRUCTURAL:

SIGMA PRIME GEOSCIENCES, INC. 332 PRINCETON AVENUE HALF MOON BAY, CA 94019

650-728-3590 SIGMAPRM@GMAIL.COM

LANDSCAPE: JERRY ALAN WHITING FLORA FARM 340 PURRISIMA ST

HALF MOON BAY, CA 94019 LIC #: 549103 650-678-5807 florafarmhmb@yahoo.com

SURVEYOR: BGT LAND SURVEYING 87 I WOODSIDE WAY

SAN MATEO, CA 94401 QBRYAN G. TAYLOR, PLS 650-212-1030 TEL 888-732-9294 FAX WWW.BGTSURVEYING.COM

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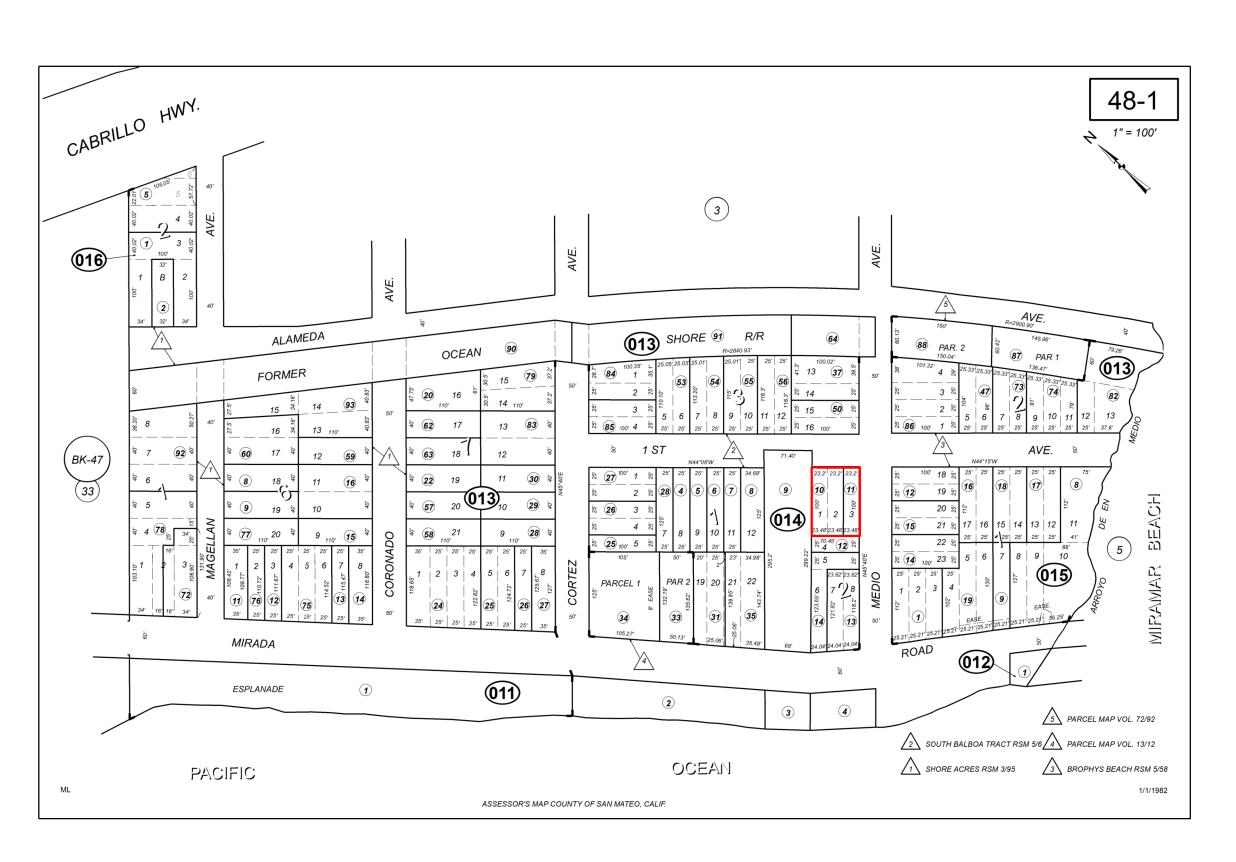
	EXISTING		PROPOSED		TOTAL			ALLOWED		
	AREA (SQFT)	%	AREA (SG	NFT) %	0	AREA (SG	(FT)	%	AREA (SQFT)	%
LOT AREA	7048					ADU HOUSE	800 1821			
LOT COVERAGE	0	0.0		1821 25	.8		1821	25.8	2467	35.0
FLOOR AREA			IST FLOOR 2ND FLOOR GARAGE ADU	1088 1472 491 800		IST FLOOR 2ND FLOOR GARAGE ADU	1088 1472 491 800			
	Total O	0.0	Total	3051 43	.3	Total	3051	43.3	Total 3735	53.0


SCOPE OF WORK:

CONSTRUCTION OF NEW SINGLE FAMILY RESIDENCE WITH ATTACHED GARAGE AND ATTACHED ADU.

NOTE:


Sheet List - CD					
Sheet					
Number	Sheet Name	Rev			
A00 I	Cover Sheet				
SU-I	Survey				
A002	Additional Notes				
C-1	Grading & Drainage Plan				
C-2	Erosion Control Plan				
C-3	ВМР				
A003	Site Plan Existing				
A004	Site Plan Proposed				
AIOI	First Floor Plan				
A102	Second Floor Plan				
A103	Roof Deck				
A104	Door \$ Window Schedule				
A105	Section				
A106	Section				
A201	Elevations				
A202	Elevations				
A501	Spec Sheets				
A502 Material Sheet					
LIOI	Landscape Plan				



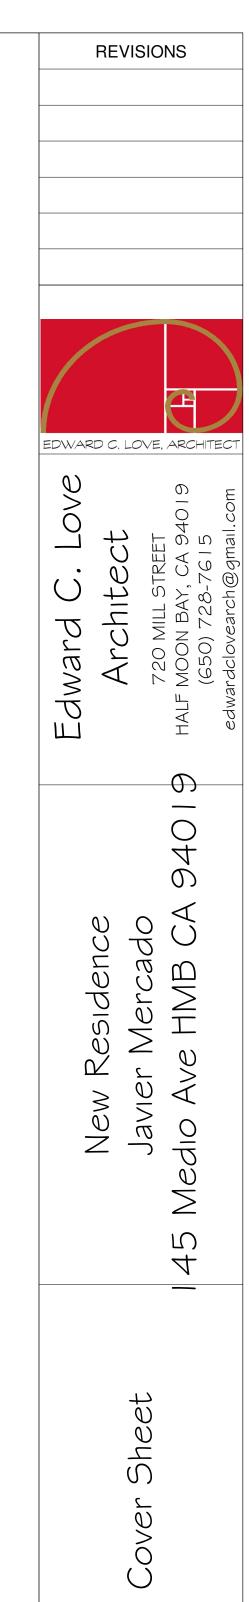

FOR REVIEW ONLY

3/27/2024 SCALE: DRAWN: Mercado

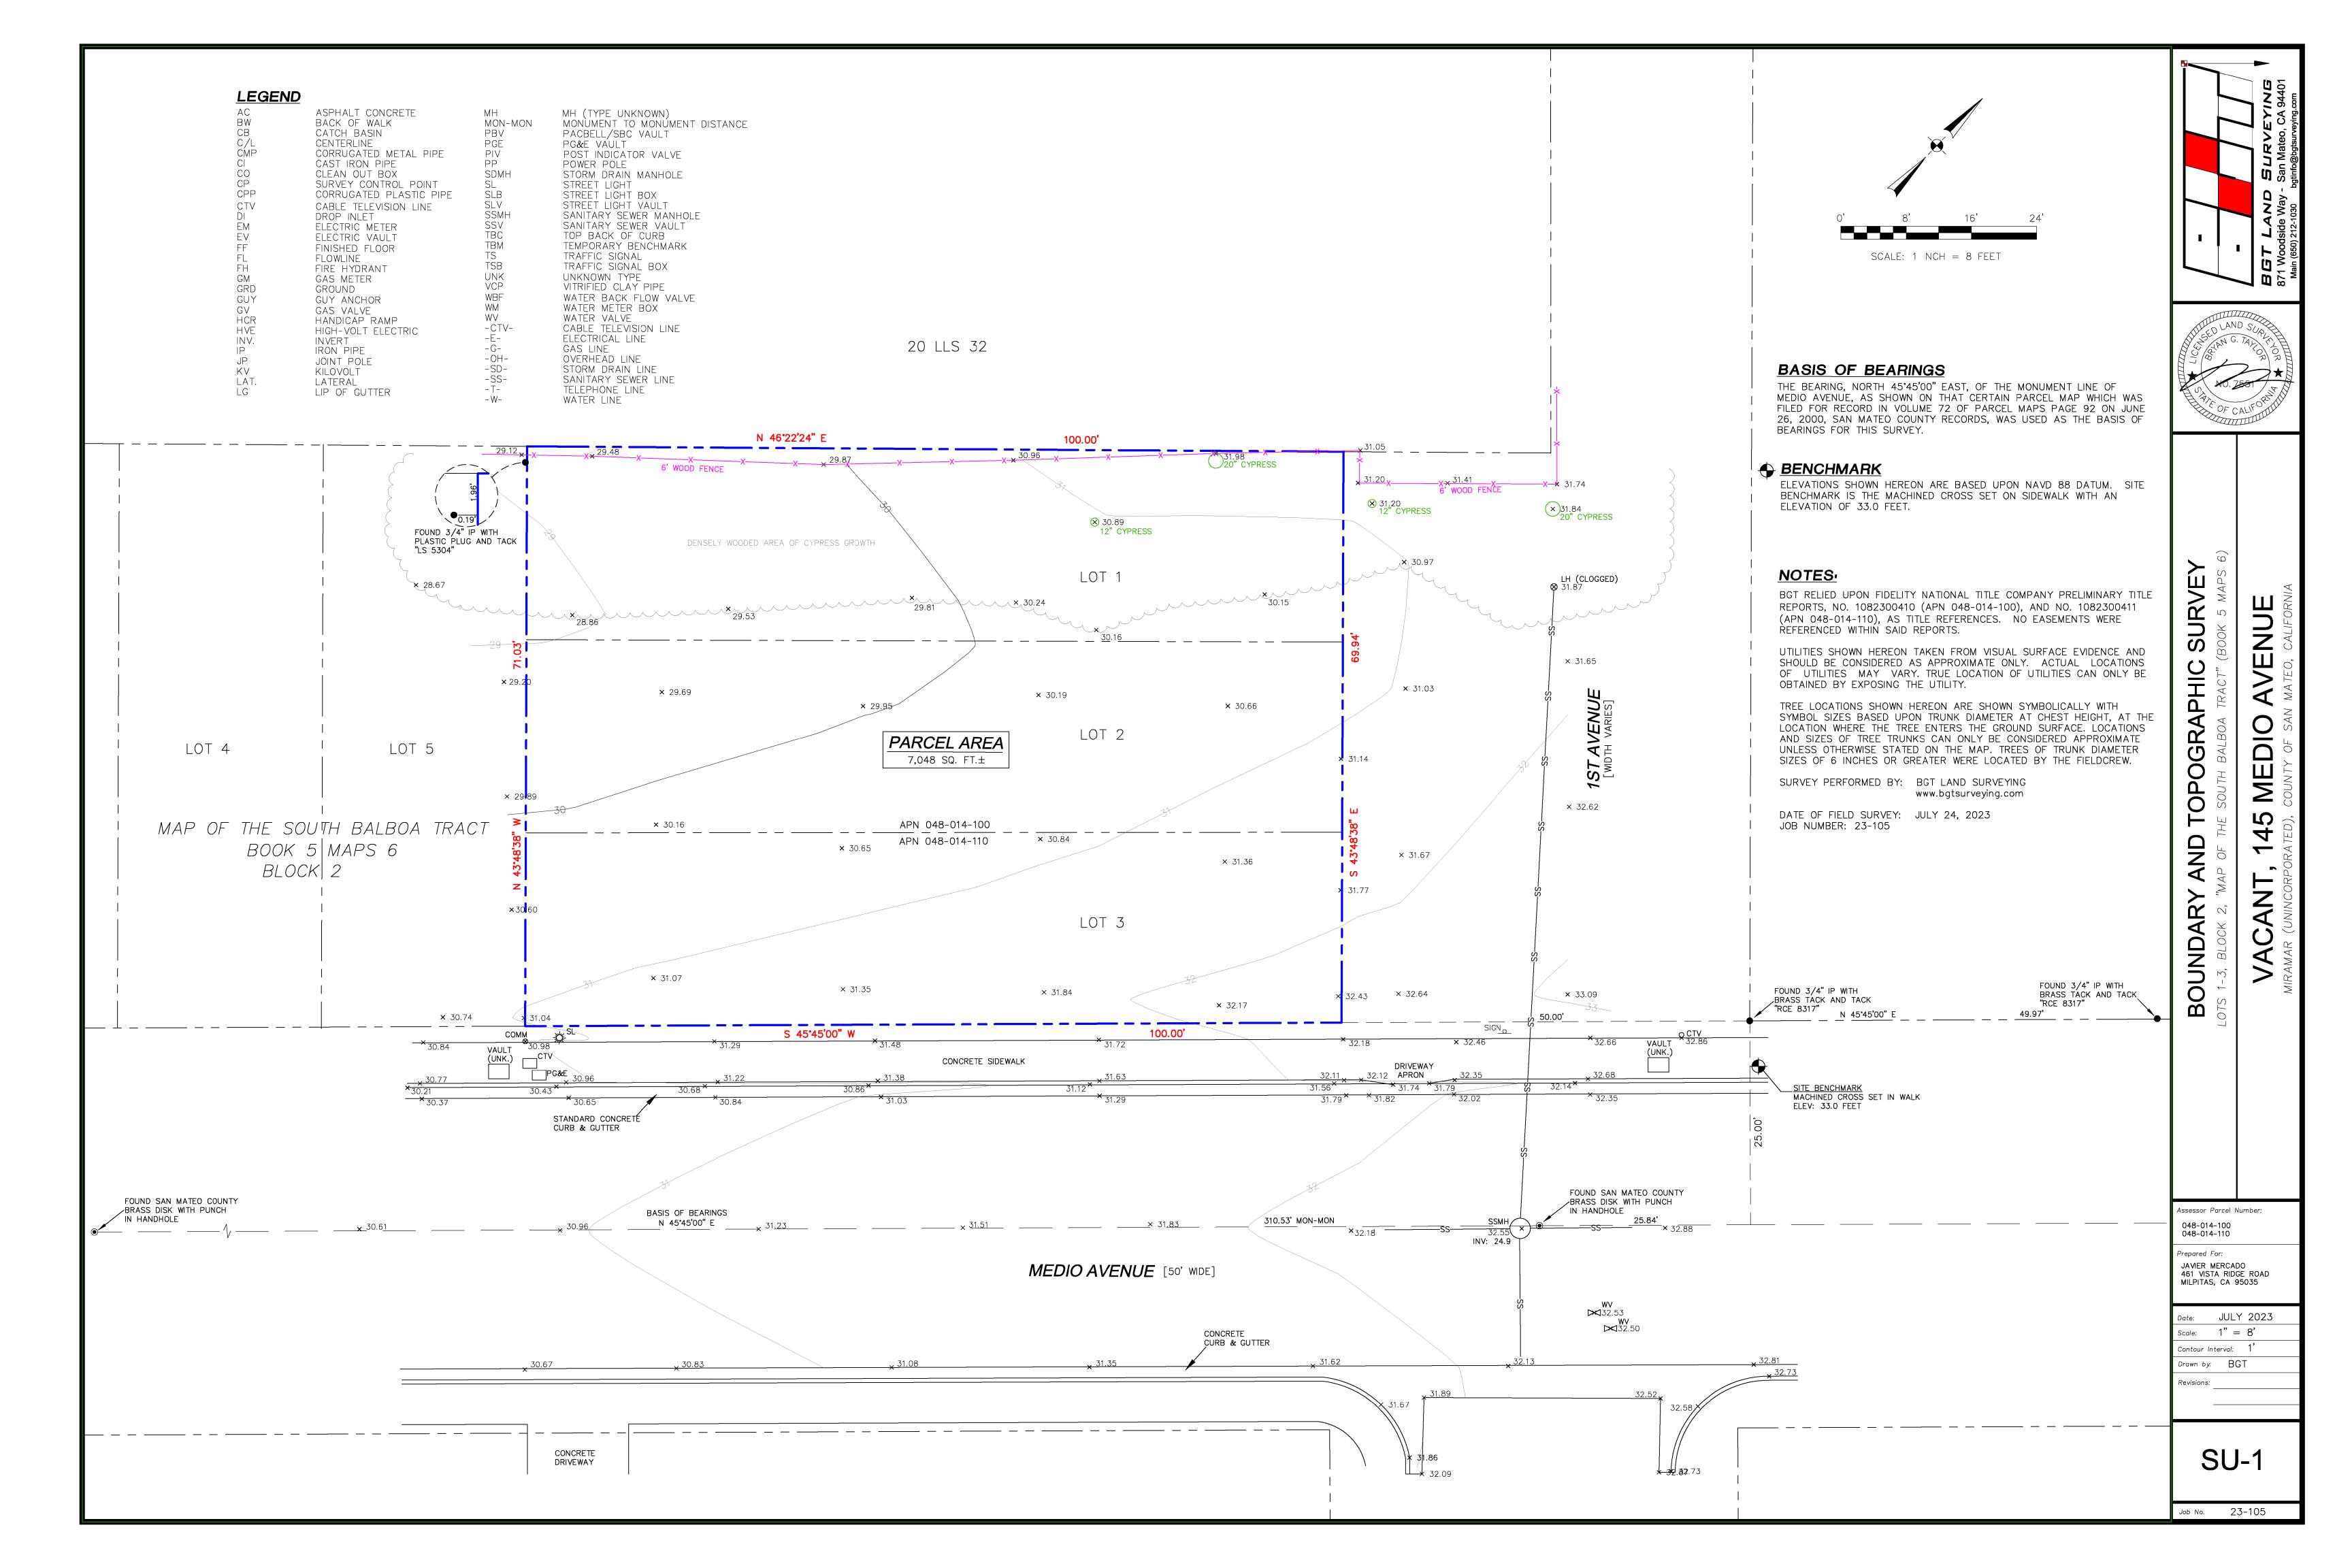

OPERATIONS & MAINTENANCE MANUALS SHALL BE PROVIDED TO BUILDING OWNER ADDRESSING ITEMS 1 - 10 IN CALGREEN 4.410.1

DUCT SYSTEMS SHALL BE SIZED, DESIGNED, AND EQUIPED PER CALGREEN 4.507.2. HVAC SYSYTEM INSTALLERS MUST BE TRAINED AND CERTIFIED AND SPECIAL INSPECTORS EMPLOYED BY THE ENFORCING AGENCY MUST BE QUALIFIED.

BATHROOM EXHAUST FANS SHALL COMPLY WITH CALGREEN 4.506.1. EACH BATHROOM SHALL BE MECHANICALLY VENTILATED WITH AN ENERGY STAR EXHAUST FAN AND MUST BE CONTROLLED BY A HUMIDITY SENSOR.

PROTECT ANNULAR SPACES AROUND PIPES, ELECTRICAL CABLES, CONDUITS OR OTHER OPENINGS AT EXTERIOR WALLS AGAINST THE PASSAGE OF RODENTS (CALGREEN 4.406.1)

COVER DUCT OPENINGS AND OTHER RELATED AIR DISTRIBUTION COMPONENT OPENINGS DURING CONSTRUCTION (CALGREEN 4.504.1)

ADHESIVES, SEALANTS, AND CAULKS SHALL BE COMPLIANT WITH VOC AND OTHER TOXIC COMPOUND LIMITS (CALGREEN 4.504.2.1)

PAINTS, STAINS, AND OTHER COATINGS SHALL BE COMPLIANT WITH VOC LIMITS (CALGREEN 4.504.2.2)

AEROSOL PAINTS AND COATINGS SHALL BE COMPLIANT WITH PRODUCT WEIGHTED MIR LIMITS FOR ROC AND TOXIC COMPOUNDS (CALGREEN 4.504.2.3). VERIFICATION OF COMPLIANCE SHALL BE PROVIDED.

CARPET AND CARPET SYSTEMS SHALL BE COMPLIANT WITH VOC LIMITS (CALGREEN 4.504.3)

MINIMUM OF 80" FLOOR AREA RECEIVING RESILIENT FLOORING SHALL COMPLY WITH CALGREEN 4.504.4

PARTICLEBOARD, MEDIUM DENSITY FIBERBOARD (MDF), AND HARDWOOD PLYWOOD USED IN INTERIOR FINISH SYSTEMS SHALL COMPLY WITH LOW FORMALDEHYDE EMISSION STANDARDS (CALGREEN 4.504.5)

INSTALL CAPILLARY BREAK AND VAPOR RETARDER AT SLAB ON GRADE FOUNDATIONS (CALLGREEN 4.505.2)

CHECK MOISTURE CONTENT OF BUILDING MATERIALS USED IN WALL AND FLOOR FRAMING BEFORE ENCLOSURE (CALGREEN 4.505.3)

HERS INSPECTION ITEMS

The following is a summary of the features that must be field-verified by a certified HERS Rater as a condition for meeting the modeled energy performance for this computer analysis. Additional detail is provided in the building components tables below.

Building-level Verifications:

• High quality insulation installation

High quality insulation installation (QII)IAQ mechanical ventilation

Cooling System Verifications:

- - None --

HVAC Distribution System Verifications:

Duct Sealing

Domestic Hot Water System Verifications:

- -- None --

Smoke Detectors

As per the California Building Code, State Fire Marshal regulations, and Coastside Fire District Ordinance 2016-01, the applicant is required to install State Fire Marshal approved and listed smoke detectors which are hard wired, interconnected, and have battery backup. These detectors are required to be placed in each new and reconditioned sleeping room and at a point centrally located in the corridor or area giving access to each separate sleeping area. In existing sleeping rooms, areas may have battery powered smoke alarms. A minimum of one detector shall be placed on each floor. Smoke detectors shall be tested and approved prior to the building final. Date of installation must be added to exterior of the smoke alarm and will be checked at final.

Smoke alarm/detector are to be hard wired, interconnected, or with battery back up. Smoke alarms to be installed per manufacturers instruction and NFPA 72.

<u>Windows</u>

Escape or rescue windows shall have a minimum net clear openable area of 5.7 square ft (sqft), 5.0 sqft allowed at grade. The minimum net clear openable height dimension shall be 24 inches. The net clear openable width dimension shall be 20 inches. Finished sill height shall not be more than 44 inches above the finished floor (CFC 1030).

Address Markers

New residential buildings shall have internally illuminated address numbers contrasting with the background so as to be seen from the public way fronting the building. The letters/numerals for permanent address signs shall be 4 inches in height with a minimum of 1/2 inch stroke. Residential address numbers shall be at least six feet above the finished surface of the driveway. Where buildings are located remotely to the public roadway, an additional signage at the driveway/roadway entrance leading to the building and/or on each individual building shall be required by the Coastside Fire District. This remote signage shall consist of a 6 inch by 18 inch green reflective metal sign with 3 inch reflective numbers/letters similar to Hy-Ko 911 or equivalent. (TEMPORARY ADDRESS NUMBERS SHALL BE POSTED PRIOR TO COMBUSTIBLES BEING PLACED ON SITE).

Roofing

As per Coastside Fire District Ordinance 2016-01, the roof covering of every new building or structure, and materials applied as part of a roof covering assembly, shall have a minimum fire rating of Class "B" or higher as defined in the current addition of the California Building Code.

Vegetation Management (LRA)

The Coastside Fire District Ordinance 2016-01, the 2016 California Fire Code 304.1.2:

A fuel break of defensible space shall is required around the perimeter of all structures to a distance of not less than 30 feet and may be required to a distance of 100 feet or to the property line. this is neither a requirement nor an authorization for the removal of living trees.

Trees located within the defensible space shall be pruned to remove dead and dying portions, and limbed up 6 feet above the ground. New trees planted in the defensible space shall be located no closer than 10 feet to adjacent trees when fully grown or at maturity.

Remove that portion of any existing trees, which extends within 10 feet of the outlet of a chimney or stovepipe or is within 5 feet of any structure. Maintain any tree adjacent to or overhanging a building free of dead or dying wood.

Fire Access Roads

The applicant must have a maintained asphalt surface road for ingress and egress of fire apparatus. The city of Half Moon Bay Department of Public Works, San Mateo County Department of Public Works, the Coastside Fire District Ordinance 2016-01, and the California Fire Code shall set road standards. As per the 2016 CFC, Deadend roads exceeding 150 feet shall be provided with a turnaround in accordance with Coastside Fire District specifications. As per the 2016 CFC, Section Appendix D, road width shall not be less than 20 feet. Fire access roads shall be installed and made serviceable prior to combustibles being placed of the project site and maintained during construction. Approved signs and painted curbs or lines shall be provided and maintained to identify fire access roads and state the prohibition of their obstruction. If the road width does not allow parking on the street (20 foot road) and on-street parking is desired, an additional improved area shall be developed for that use.

Fire Hydrant

As per 2016 CFC, Appendix B and C, a fire district approved fire hydrant (Clow 960) must be located within 500 feet of the proposed single-family dwelling unit measured by way of drivable access. As per 2016 CFC, Appendix B the hydrant must produce a minimum fire flow of 500 gallons per minute at 20 pounds per square inch residual pressure for 2 hours. Contact the local water purveyor for water flow details.

<u>Automatic Fire Sprinkler System</u> (Fire Sprinkler plans will require a separate permit)

As per San Mateo County Building Standards and Coastside Fire District Ordinance 2016-01, the applicant is required to install an automatic fire sprinkler system throughout the proposed or improved dwelling and garage. All attic access locations will be provided with a pilot head on metal upright. Sprinkler coverage shall be provided throughout the residence to include all bathrooms, garages, and any area used for storage. The only exception is small linen closets less than 24 square feet with full depth shelving. The plans for this system must be submitted to the San Mateo County Planning and Building Division or the City of HMB. A building permit will not be issued until plans are received, reviewed, and approved. Upon submission of plans, the County or City will forward a complete set to the Coastside Fire District for review.

Installation of underground sprinkler pipe shall be flushed and visually inspected by Fire District prior to hook-up to riser. Any soldered fittings must be pressure tested with trench open. Please call Coastside Fire District to schedule an inspection. Fees shall be paid prior to plan review.

An exterior bell and interior horn/strobe are required to be wired into the required flow switch on your fire sprinkler system. The bell, horn/strobe, and flow switch, along with the garage door opener, are to be wired into a separate circuit breaker at the main electrical panel and labeled.

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Solar Photovoltaic Systems

These systems shall meet the requirements of the 2016 CFC Section 605.11.


REVISIONS

EDWARD C. LOVE, ARCHITEC

Iward C. Love
Architect
720 MILL STREET
MOON BAY, CA 94019

New Residence Javier Mercado

Additional Note

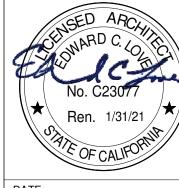

DATE: 3/27/2024
SCALE:


DRAWN: GI

JOB: Mercado


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ardclovearch@qmail.com

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n Proposed 145 Me


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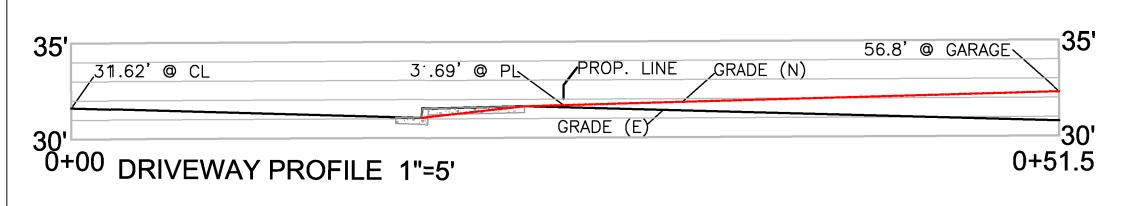
Site

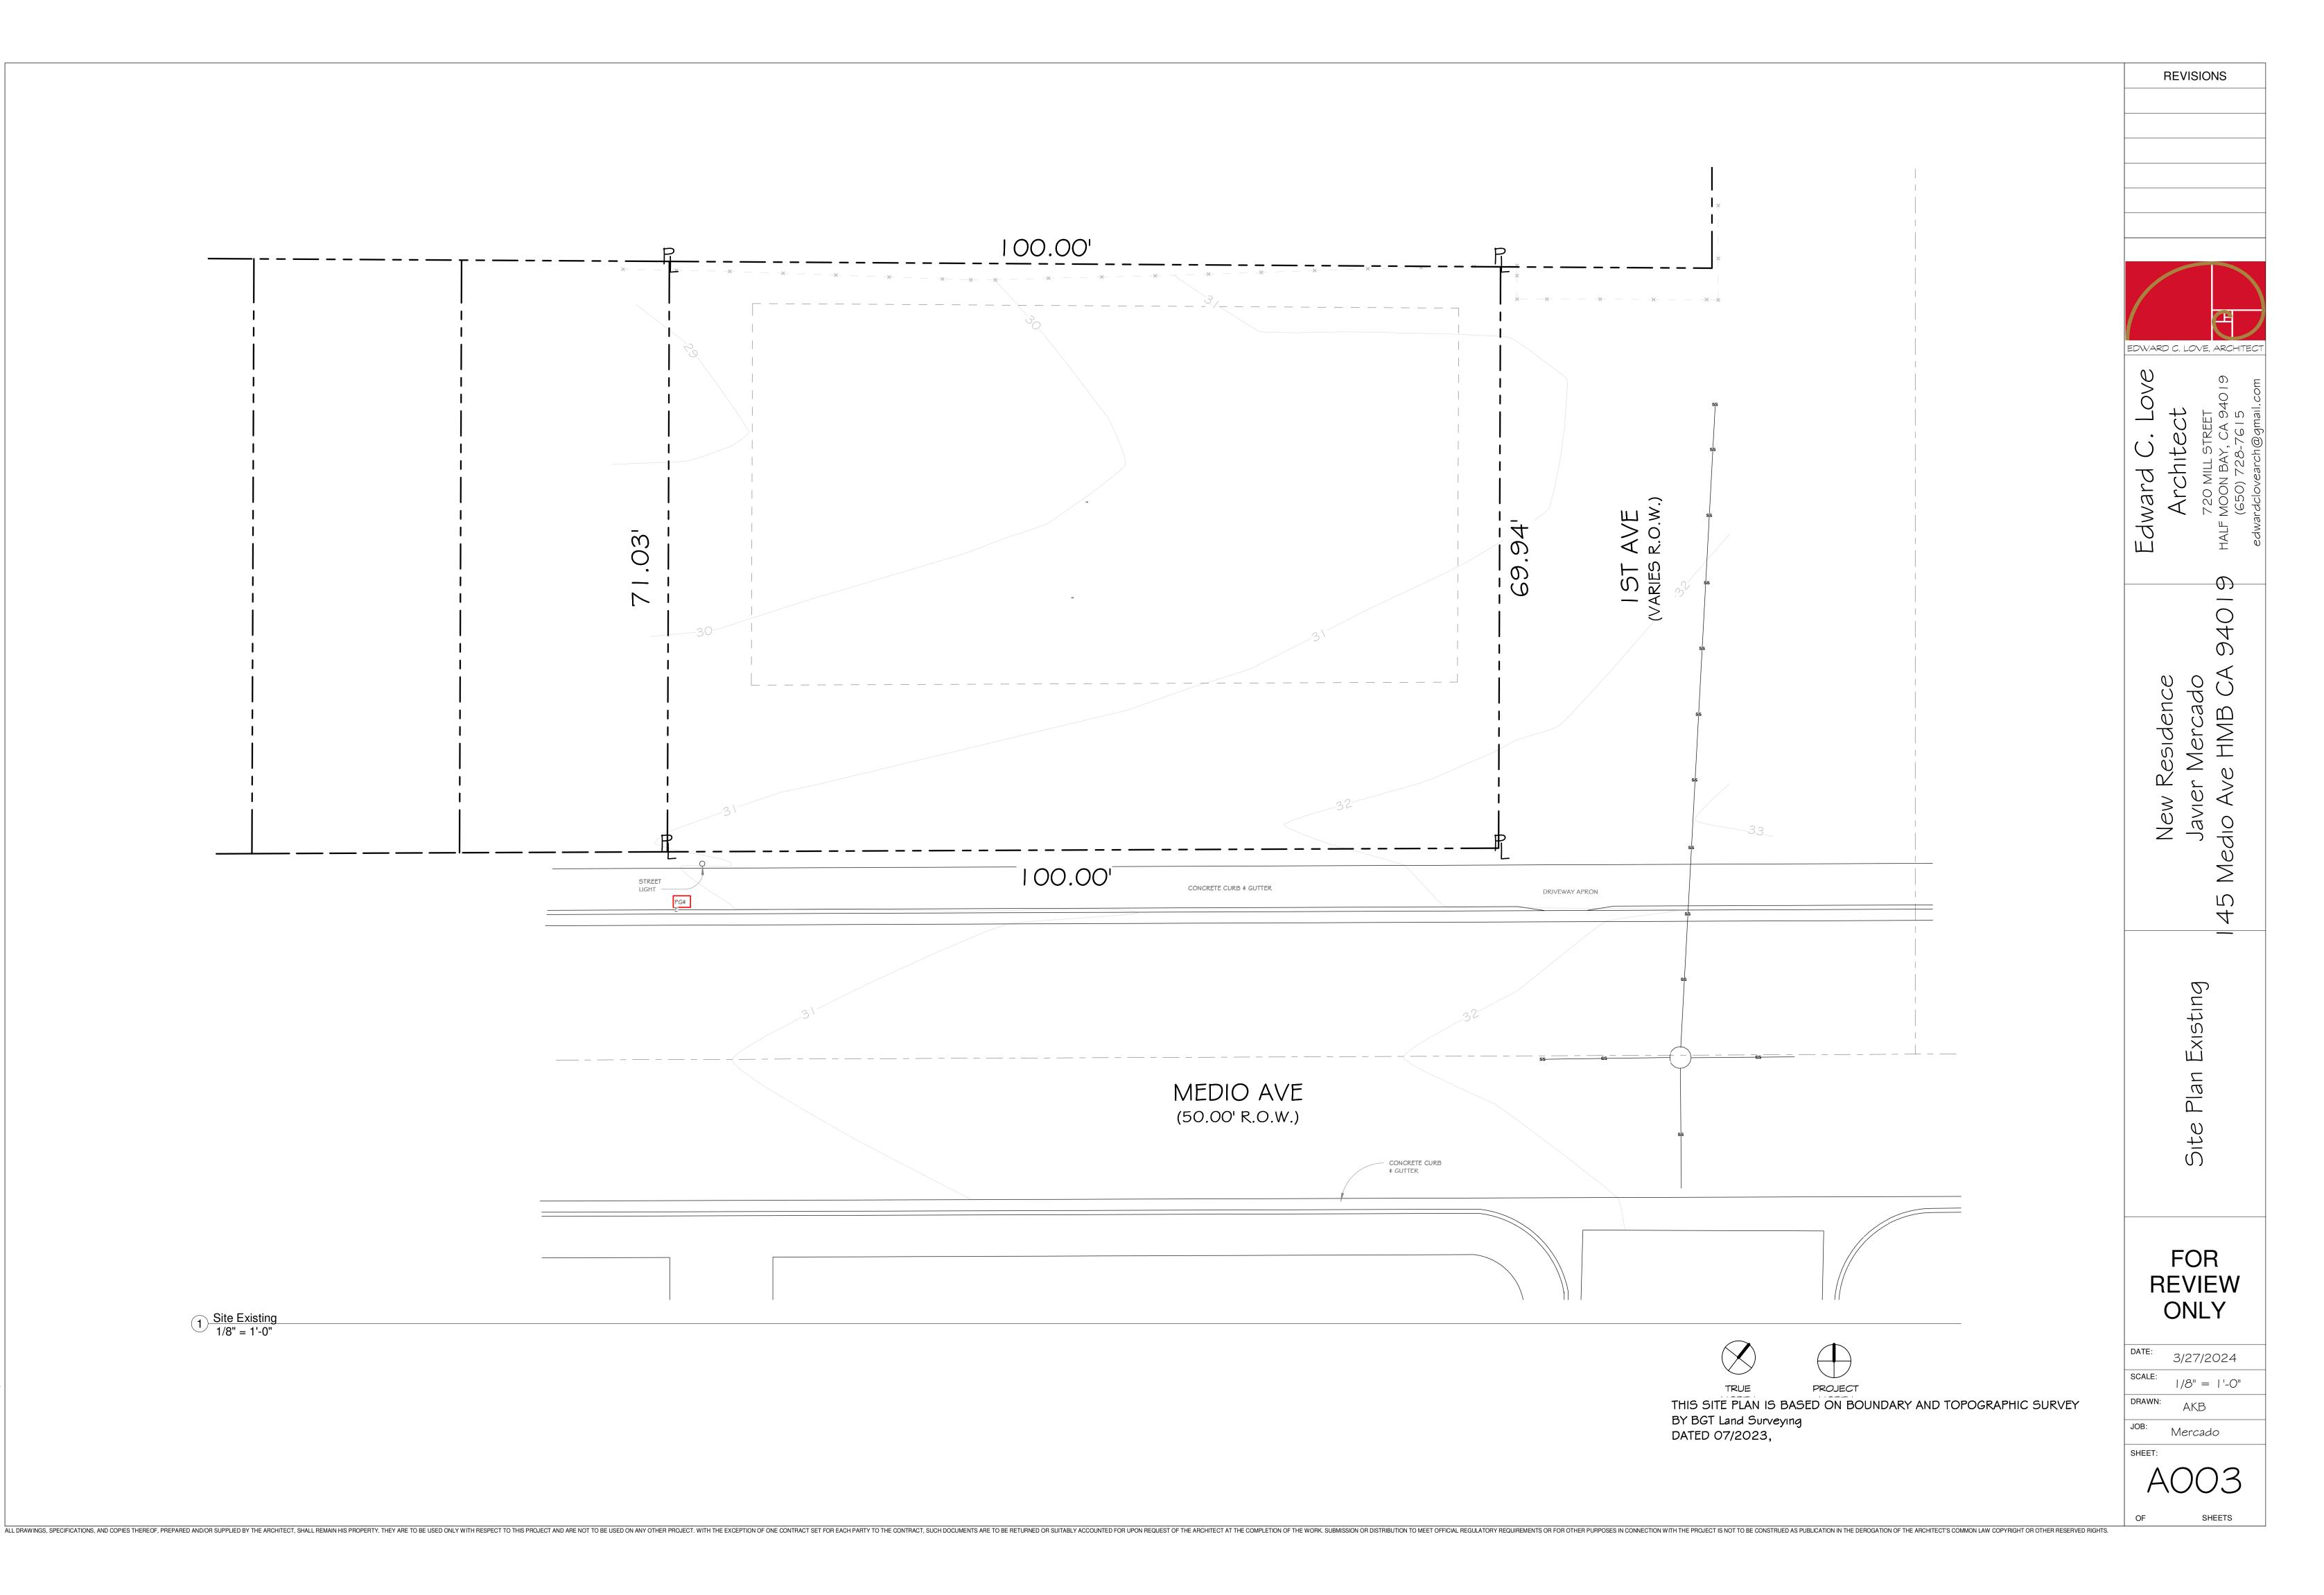DATE: 3/27/2024SCALE: 1/8'' = 1'-0''DRAWN: AKB

JOB: Mercado

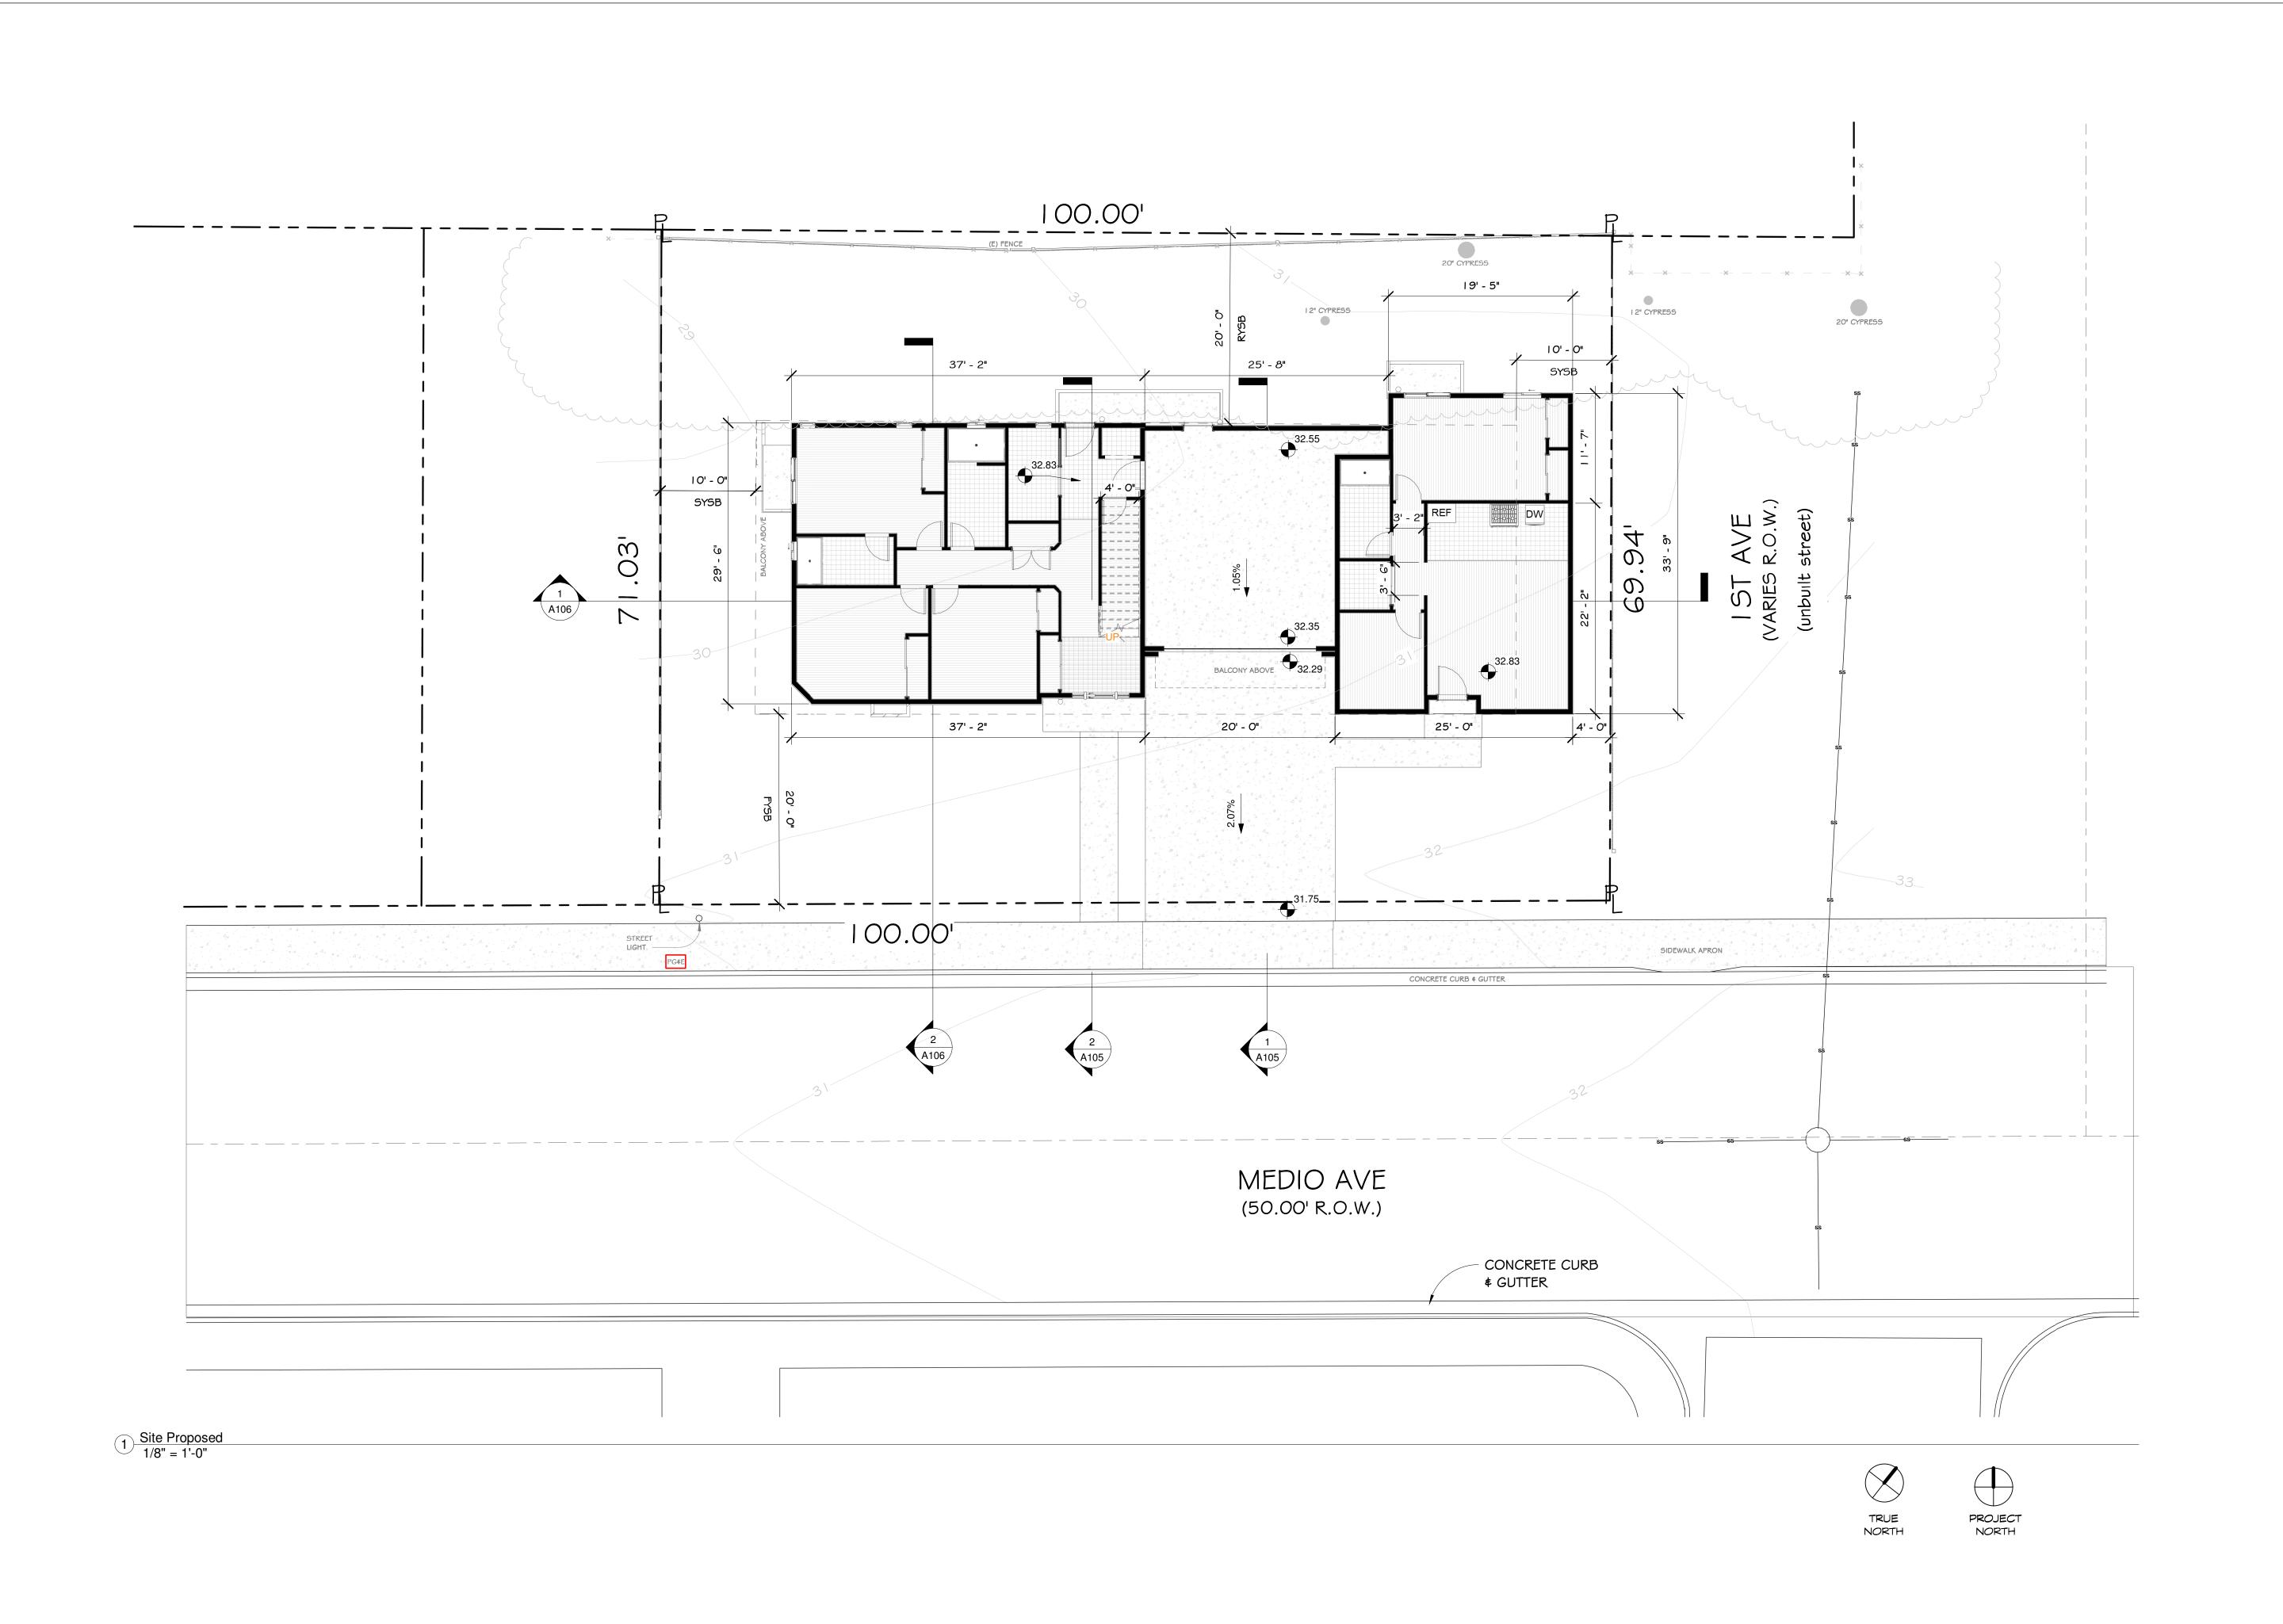SHEET:



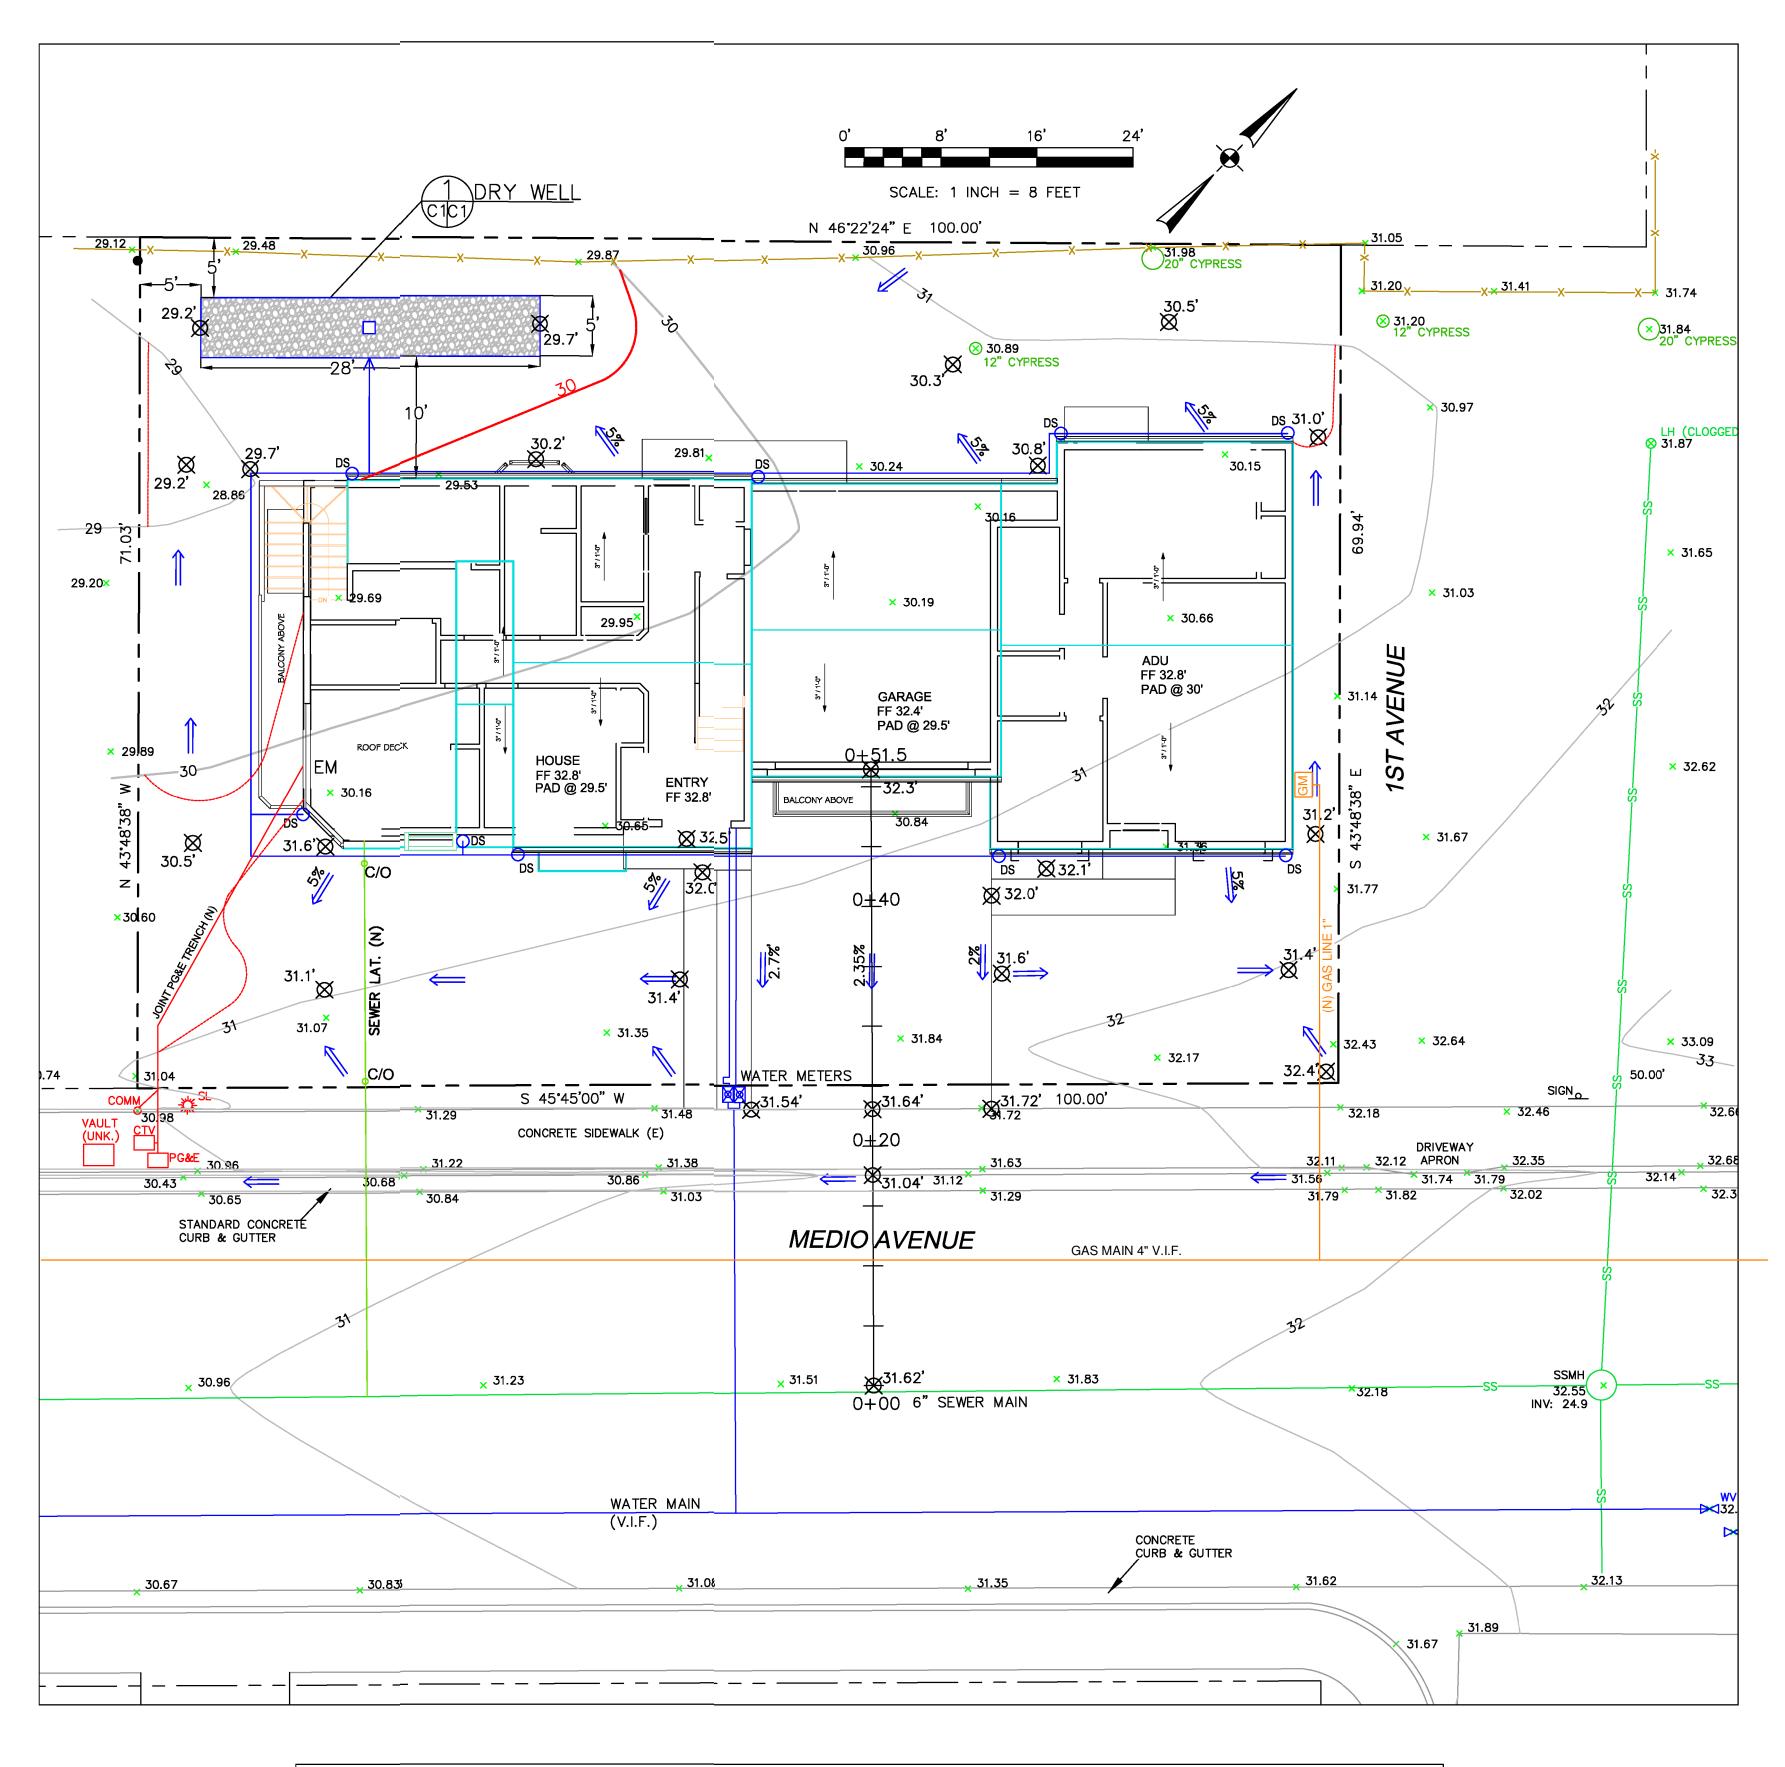

LEGEND

EXISTING CONTOURS

PROPOSED CONTOURS

imes 30.97 EXISTING SPOT ELEVATION

₹31.0' PROPOSED SPQT ELEVATION



DRAINAGE NOTES

- 1. DRAINAGE INTENT: IT IS THE INTENT OF THE DRAINAGE SYSTEM TO CONVEY ROOF RUNOFF TO A SAFE LOCATION, AND TO MINIMIZE EXCESSIVE MOISTURE AROUND FOUNDATIONS. DIRECT SLOPES SUCH THAT STORMWATER WILL NOT BE DIVERTED ONTO ADJACENT PROPERTIES.
- 2. ALL NEW DOWNSPOUT DRAIN LINES SHALL LEAD TO DRY WELL, AS
- 3. ALL ROOF DRAINAGE PIPES SHALL BE 4" DIAMETER MINIMUM SOLID PIPE, SLOPED AT 1% MINIMUM.
- 4. IT IS THE PROPERTY OWNER'S RESPONSIBILITY TO CHECK ON ALL STORMWATER FACILITIES SUCH AS ROOF GUTTERS, DOWNSPOUT LINES, AND THE DRY WELL TO BE SURE THAT THEY ARE CLEAR OF EXCESSIVE DEBRIS AND OPERATING EFFICIENTLY. THE FACILITIES SHALL BE CHECKED EVERY FALL AND PERIODICALLY DURING THE RAINY SEASON.

GRADING NOTES

CUT VOLUME: 10 CY (FOR FOUNDATION) FILL VOLUME: 0 CY


VOLUMES ABOVE ARE APPROXIMATE.

THE SUBGRADE BELOW ALL PAVED AREAS SHALL BE BASEROCK COMPACTED TO 95%.

ALL GRADING SHALL CONFORM TO LOCAL CODES AND ORDINANCES.

ALL TRENCHES UNDER PROPOSED PAVED AREAS OR CONCRETE SHALL BE BACKFILLED TO SUBGRADE ELEVATION WITH COMPACTED APPROVED GRANULAR MATERIALS. IF TRENCHES ARE IN PROPOSED LANDSCAPE AREAS, THEY SHALL BE BACKFILLED WITH COMPACTED APPROVED GRANULAR MATERIAL TO WITHIN ONE FOOT OF FINISHED GRADE, AND THEN FILLED WITH HAND TAMPED SOILS.


SECTION AND DETAIL CONVENTION

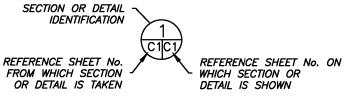




GENERAL NOTES


- 1. PLANS PREPARED AT THE REQUEST OF:
- JAVIER MERCADO, OWNER
- 2. TOPOGRAPHY BY BGT LAND SURVEYING, SURVEYED 7-24-23.
- 3. THIS IS NOT A BOUNDARY SURVEY.
- 4. ELEVATION DATUM NAVD88.

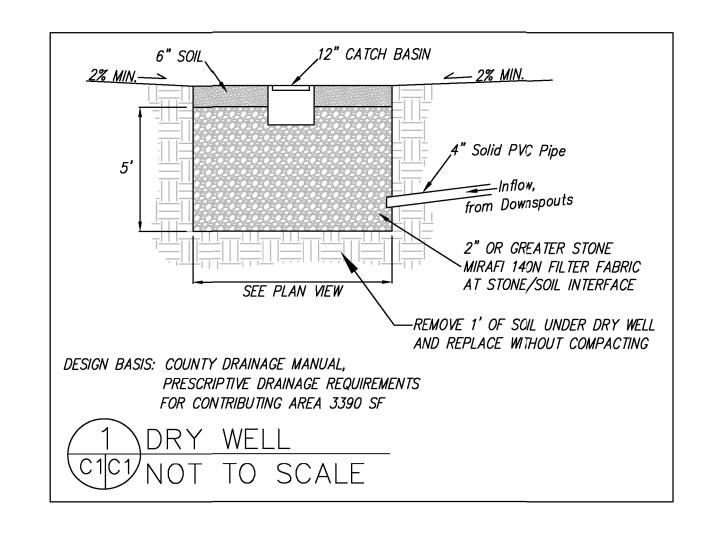

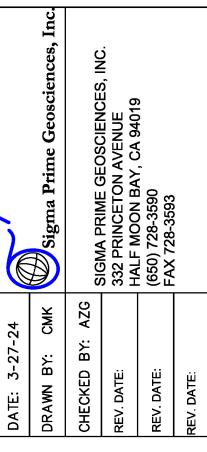


MERCADO PROPERTY 145 MEDIO AVENUE MIRMAR APN 048-014-100,110 AND PLAN GRADING DRAINAGE


SHEET

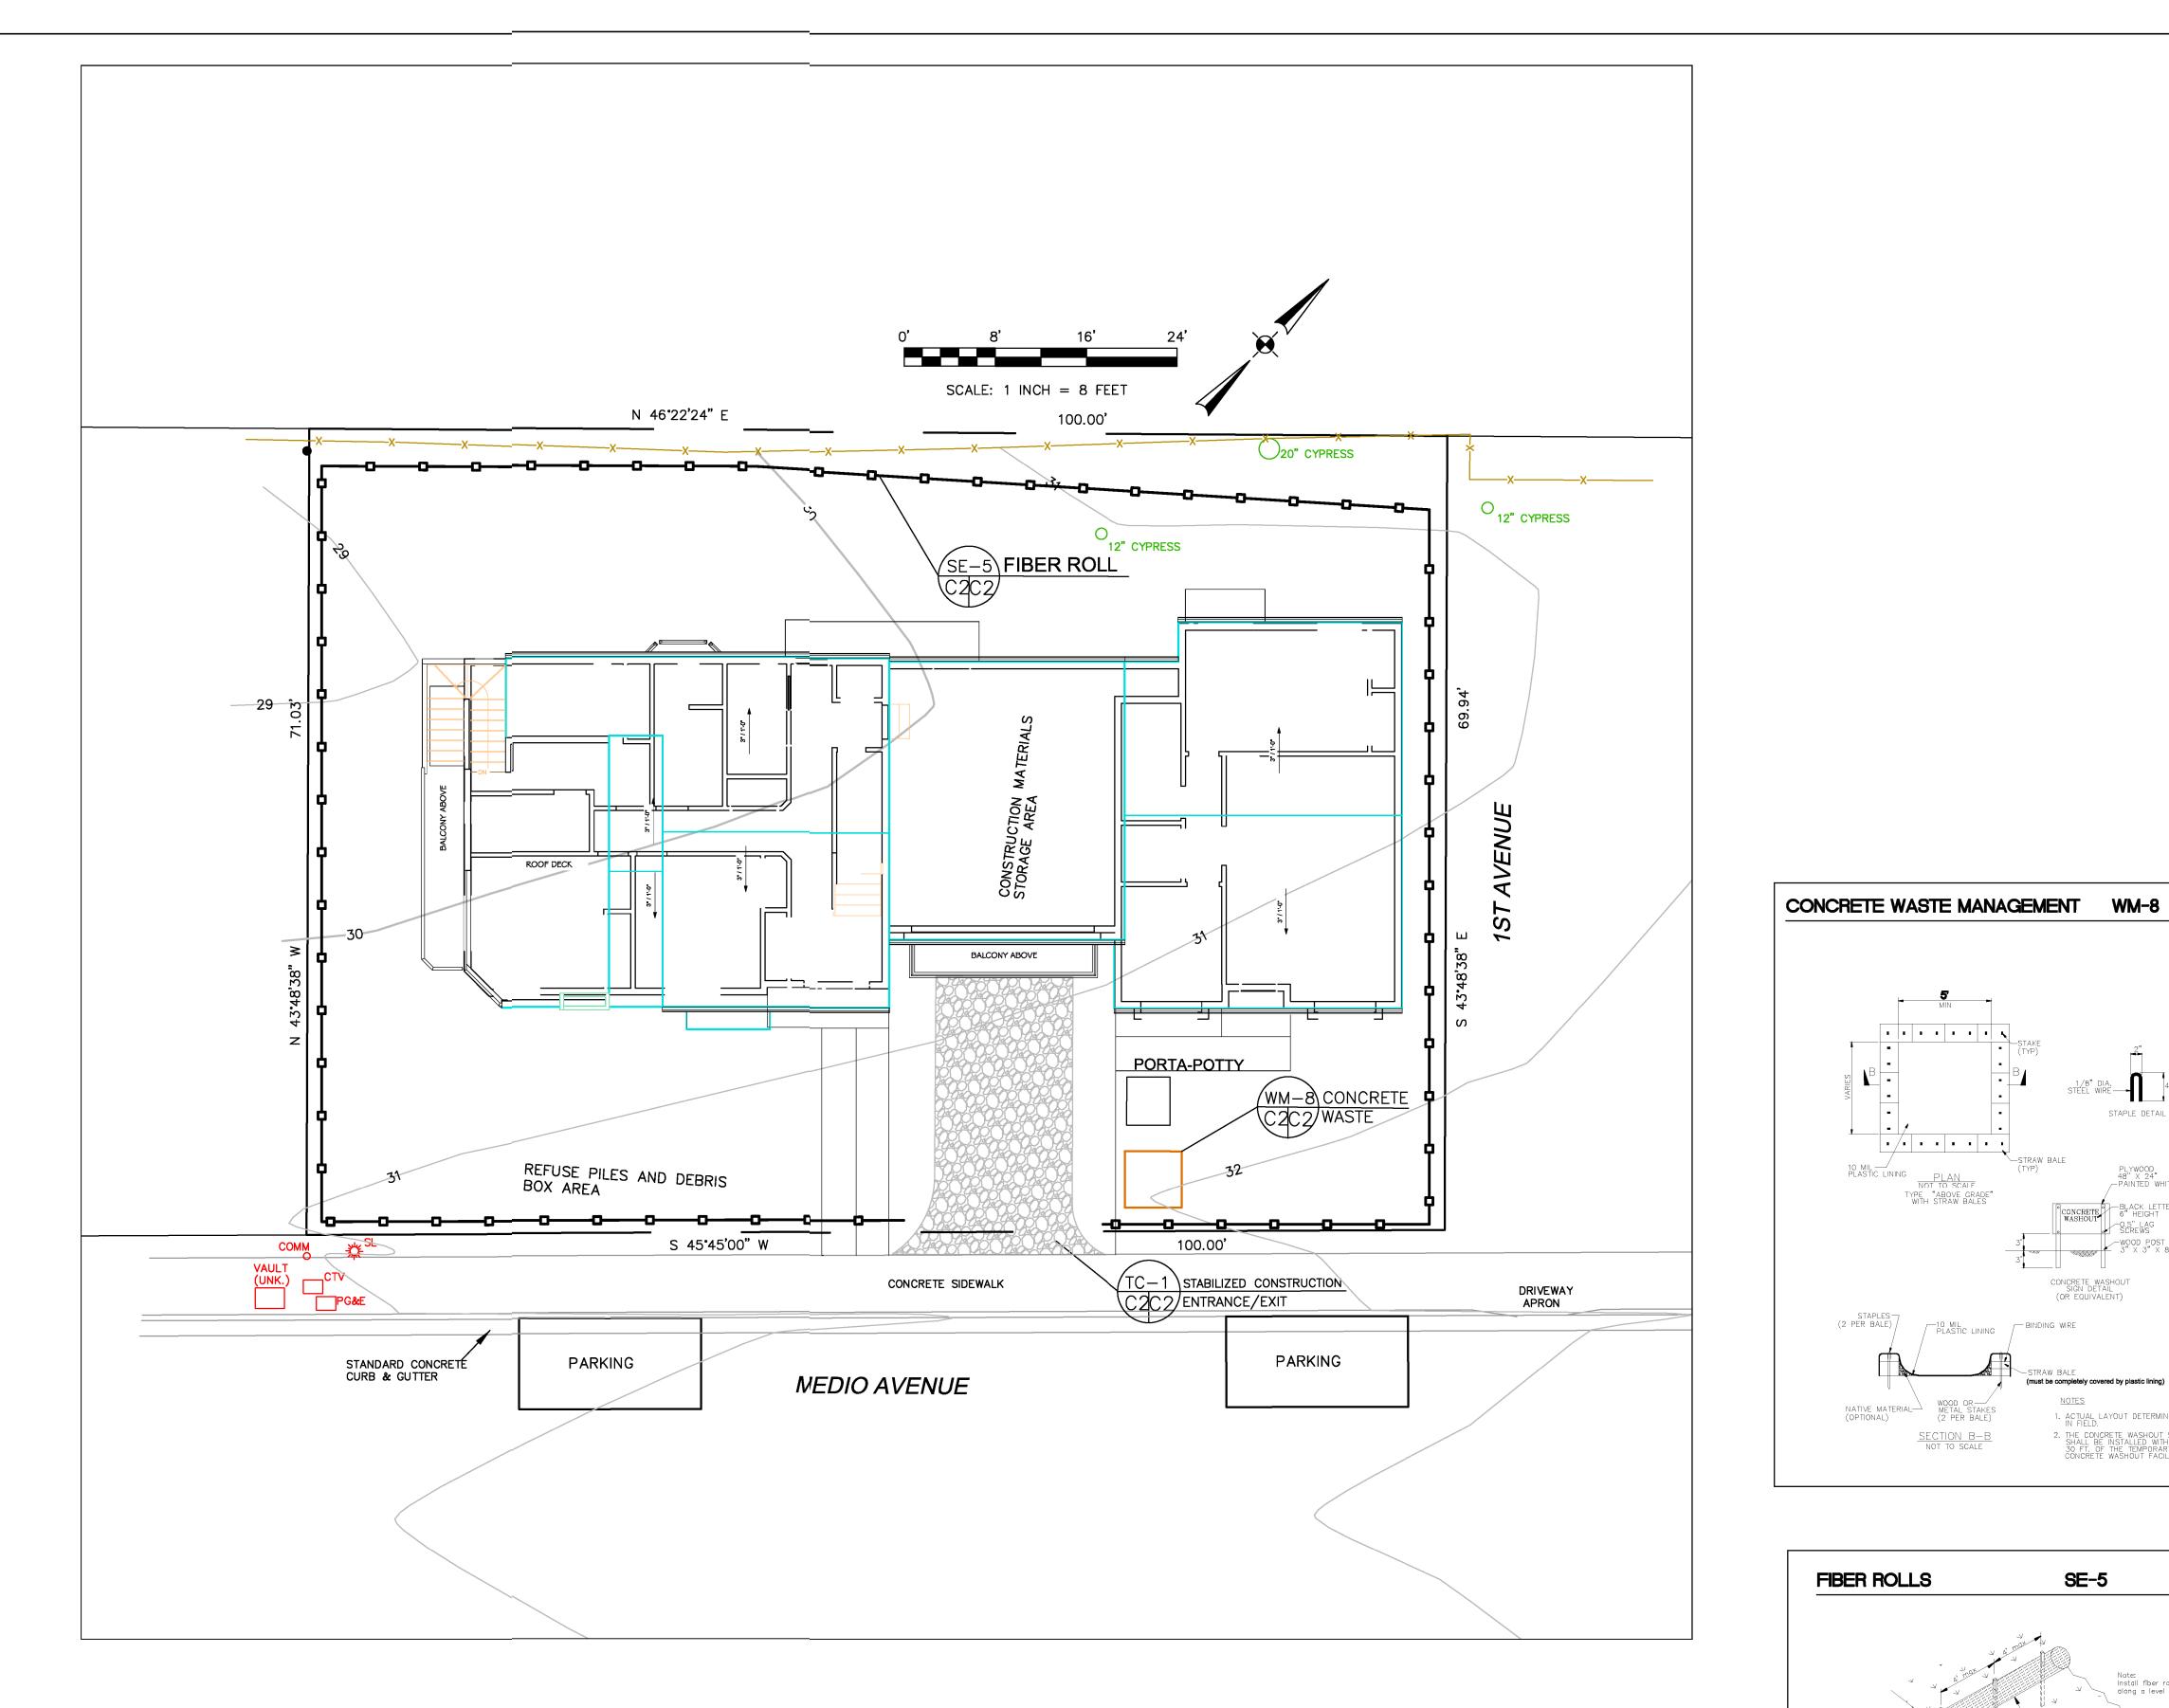


GENERAL EROSION AND SEDIMENT CONTROL NOTES

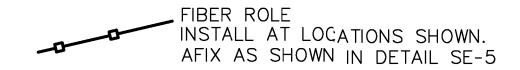

- There will be no stockpiling of soil. All excavated soil will be hauled off-site as it is excavated.
- · Perform clearing and earth-moving activities only during dry weather. Measures to ensure adequate erosion and sediment control shall be installed prior to earth-moving activities and construction.
- · Erosion control materials to be on-site during off-season.
- · Measures to ensure adequate erosion and sediment control are required year-round. Stabilize all denuded areas and maintain erosion control measures continuously between October 1 and April 30.
- · Store, handle, and dispose of construction materials and wastes properly, so as to prevent their contact with stormwater.
- · Control and prevent the discharge of all potential pollutants, including pavement cutting wastes, paints, concrete, petroleum products, chemicals, wash water or sediments, and non-stormwater discharges to storm drains and watercourses.
- · Avoid cleaning, fueling, or maintaining vehicles on-site, except in a designated area where wash water is contained and treated.
- · Limit and time applications of pesticides and fertilizers to prevent polluted runoff.
- · Limit construction access routes to stabilized, designated access points
- · Avoid tracking dirt or other materials off-site; clean off-site paved areas and sidewalks using dry sweeping methods.
- · Train and provide instruction to all employees and subcontractors regarding the Watershed Protection Maintenance Standards and construction Best Management Practices.
- · Placement of erosion materials is required on weekends and during rain events.
- The areas delineated on the plans for parking, grubbing, storage etc., shall not be enlarged or "run over."
- Dust control is required year-round.
- · Erosion control materials shall be stored on-site.

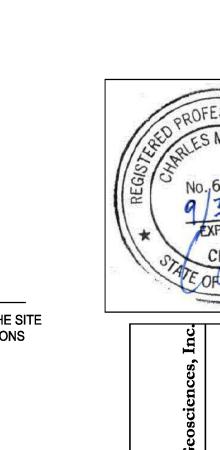

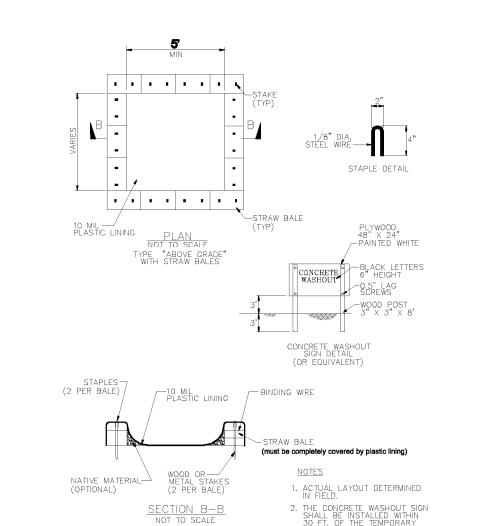

SE-5

ENTRENCHMENT DETAIL N.T.S.


If more than one fiber roll is placed in a row, the rolls must be overlapped, not abutted Turn the ends of the fiber roll up-slope to prevent runoff from going around the roll.


FIBER ROLLS


EROSION CONTROL POINT OF CONTACT

THIS PERSON WILL BE RESPONSIBLE FOR EROSION CONTROL AT THE SITE AND WILL BE THE COUNTY'S MAIN POINT OF CONTACT IF CORRECTIONS ARE REQUIRED.

ARE REQUIR	LD.		
NAME:	CHARLES KIS	SSICK	
TITLE/QUALI	FICATION:	PROJECT ENGINEER	
PHONE:	650-728-3	3590	
PHONE:			
E-MAIL:	SIGMAPR	RM@GMAIL.COM	

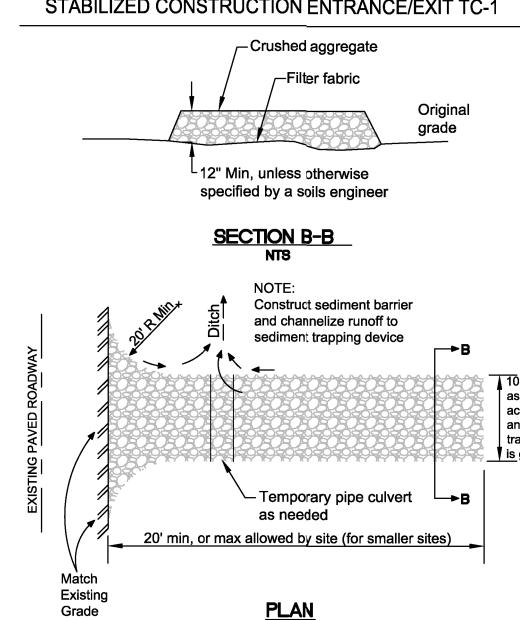

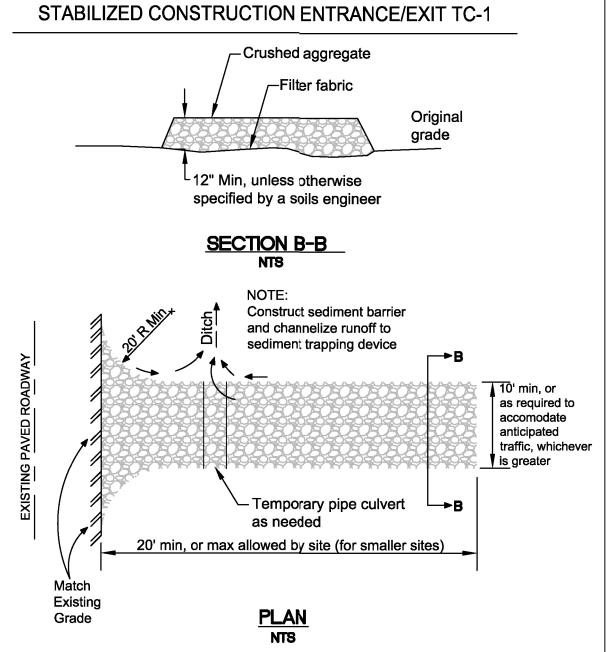

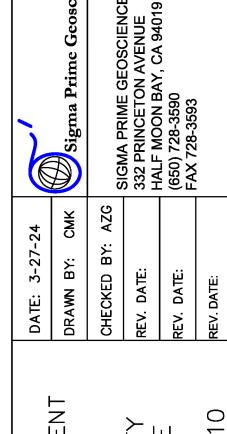

SEDIMENT PLAN MERCADO PROPERTY 145 MEDIO AVENUE MIRMAR APN 048-014-100,110 EROSION AND CONTROL

SHEET

C-2




Construction Best Management Practices (BMPs)

Construction projects are required to implement the stormwater best management practices (BMP) on this page, as they apply to your project, all year long.

Clean Water. Healthy Community.

Materials & Waste Management

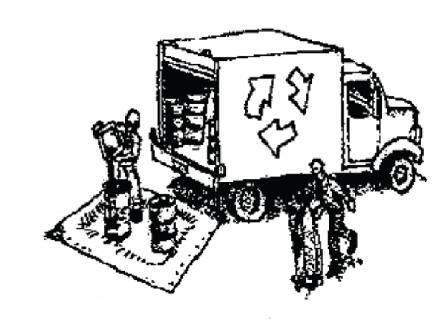

Non-Hazardous Materials

- ☐ Berm and cover stockpiles of sand, dirt or other construction material with tarps when rain is forecast or if not actively being used within 14 days.
- ☐ Use (but don't overuse) reclaimed water for dust control.

Hazardous Materials

- ☐ Label all hazardous materials and hazardous wastes (such as pesticides, paints, thinners, solvents, fuel, oil, and antifreeze) in accordance with city, county, state and federal regulations.
- ☐ Store hazardous materials and wastes in water tight containers, store in appropriate secondary containment, and cover them at the end of every work day or during wet weather or when rain is forecast.
- ☐ Follow manufacturer's application instructions for hazardous materials and be careful not to use more than necessary. Do not apply chemicals outdoors when rain is forecast within 24 hours.
- Arrange for appropriate disposal of all hazardous wastes.

Waste Management

- Cover waste disposal containers securely with tarps at the end of every work day and during wet weather.
- Check waste disposal containers frequently for leaks and to make sure they are not overfilled. Never hose down a dumpster on the construction site.
- Clean or replace portable toilets, and inspect them frequently for leaks and spills.
- Dispose of all wastes and debris properly. Recycle materials and wastes that can be recycled (such as asphalt, concrete, aggregate base materials, wood, gyp board, pipe, etc.)
- Dispose of liquid residues from paints, thinners, solvents, glues, and cleaning fluids as hazardous waste.

Construction Entrances and Perimeter

- Establish and maintain effective perimeter controls and stabilize all construction entrances and exits to sufficiently control erosion and sediment discharges from site and tracking off site.
- Sweep or vacuum any street tracking immediately and secure sediment source to prevent further tracking. Never hose down streets to clean up tracking.

Equipment Management & Spill Control




Maintenance and Parking

- Designate an area, fitted with appropriate BMPs, for vehicle and equipment parking and storage.
- ☐ Perform major maintenance, repair jobs, and vehicle and equipment washing off site.
- ☐ If refueling or vehicle maintenance must be done onsite, work in a bermed area away from storm drains and over a drip pan or drop cloths big enough to collect fluids. Recycle or dispose of fluids as hazardous waste.
- ☐ If vehicle or equipment cleaning must be done onsite, clean with water only in a bermed area that will not allow rinse water to run into gutters, streets, storm drains, or surface waters.
- ☐ Do not clean vehicle or equipment onsite using soaps, solvents, degreasers, or steam cleaning equipment.

Spill Prevention and Control

- Keep spill cleanup materials (e.g., rags, absorbents and cat litter) available at the construction site at all times.
- Inspect vehicles and equipment frequently for and repair leaks promptly. Use drip pans to catch leaks until repairs are made.
- Clean up spills or leaks immediately and dispose of cleanup materials properly.
- Do not hose down surfaces where fluids have spilled. Use dry cleanup methods (absorbent materials, cat litter, and/or rags).
- Sweep up spilled dry materials immediately. Do not try to wash them away with water, or bury them.
- Clean up spills on dirt areas by digging up and properly disposing of contaminated soil.
- Report significant spills immediately. You are required by law to report all significant releases of hazardous materials, including oil. To report a spill: 1) Dial 911 or your local emergency response number, 2) Call the Governor's Office of Emergency Services Warning Center, (800) 852-7550 (24 hours).

Earthmoving

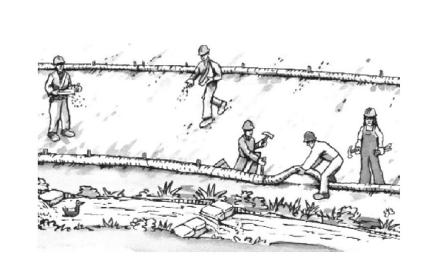


- Schedule grading and excavation work during dry weather.
- Stabilize all denuded areas, install and maintain temporary erosion controls (such as erosion control fabric or bonded fiber matrix) until vegetation is established.
- Remove existing vegetation only when absolutely necessary, and seed or plant vegetation for erosion control on slopes or where construction is not immediately planned.
- Prevent sediment from migrating offsite and protect storm drain inlets, gutters, ditches, and drainage courses by installing and maintaining appropriate BMPs, such as fiber rolls, silt fences, sediment basins, gravel bags, berms, etc.
- ☐ Keep excavated soil on site and transfer it to dump trucks on site, not in the streets.

Contaminated Soils

- If any of the following conditions are observed, test for contamination and contact the Regional Water Quality Control Board:
- Unusual soil conditions, discoloration or odor.
- Abandoned underground tanks.
- Abandoned wells
- Buried barrels, debris, or trash.

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Paving/Asphalt Work

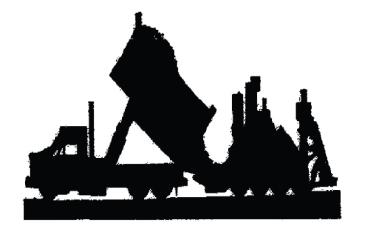


- ☐ Avoid paving and seal coating in wet weather or when rain is forecast, to prevent materials that have not cured from contacting stormwater runoff.
- ☐ Cover storm drain inlets and manholes when applying seal coat, tack coat, slurry seal, fog seal, etc.
- ☐ Collect and recycle or appropriately dispose of excess abrasive gravel or sand. Do NOT sweep or wash it into gutters.
- ☐ Do not use water to wash down fresh asphalt concrete pavement.

Sawcutting & Asphalt/Concrete Removal


- ☐ Protect nearby storm drain inlets when saw cutting. Use filter fabric, catch basin inlet filters, or gravel bags to keep slurry out of the storm drain system.
- ☐ Shovel, abosorb, or vacuum saw-cut slurry and dispose of all waste as soon as you are finished in one location or at the end of each work day (whichever is sooner!).
- ☐ If sawcut slurry enters a catch basin, clean it up immediately.

A

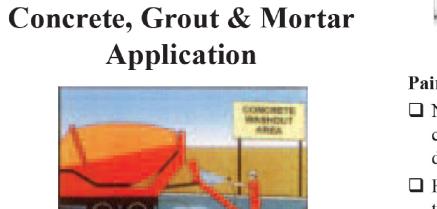


- ☐ Store concrete, grout, and mortar away from storm drains or waterways, and on pallets under cover to protect them from rain, runoff, and wind.
- ☐ Wash out concrete equipment/trucks offsite or in a designated washout area, where the water will flow into a temporary waste pit, and in a manner that will prevent leaching into the underlying soil or onto surrounding areas. Let concrete harden and dispose of as garbage.
- ☐ When washing exposed aggregate, prevent washwater from entering storm drains. Block any inlets and vacuum gutters, hose washwater onto dirt areas, or drain onto a bermed surface to be pumped and disposed of properly.

Landscaping

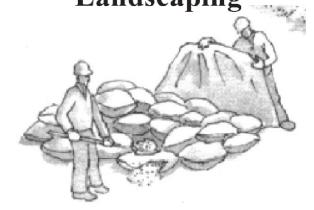

- ☐ Protect stockpiled landscaping materials from wind and rain by storing them under tarps all year-round.
- ☐ Stack bagged material on pallets and under cover.
- ☐ Discontinue application of any erodible landscape material within 2 days before a forecast rain event or during wet weather.


Painting & Paint Removal

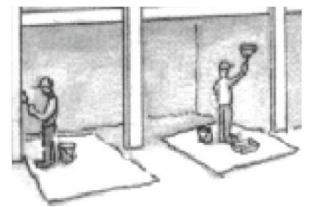

Painting Cleanup and Removal

- ☐ Never clean brushes or rinse paint containers into a street, gutter, storm drain, or stream.
- ☐ For water-based paints, paint out brushes to the extent possible, and rinse into a drain that goes to the sanitary sewer.

 Never pour paint down a storm drain.
- ☐ For oil-based paints, paint out brushes to the extent possible and clean with thinner or solvent in a proper container. Filter and reuse thinners and solvents. Dispose of excess liquids as hazardous waste.
- ☐ Paint chips and dust from non-hazardous dry stripping and sand blasting may be swept up or collected in plastic drop cloths and disposed of as trash.
- ☐ Chemical paint stripping residue and chips and dust from marine paints or paints containing lead, mercury, or tributyltin must be disposed of as hazardous waste. Lead based paint removal requires a statecertified contractor.

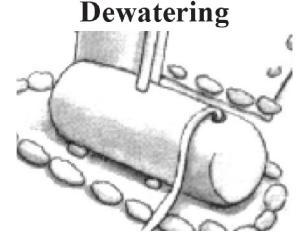

- Discharges of groundwater or captured runoff from dewatering operations must be properly managed and disposed. When possible send dewatering discharge to landscaped area or sanitary sewer. If discharging to the sanitary sewer call your local wastewater treatment plant.
- ☐ Divert run-on water from offsite away from all disturbed areas.
- ☐ When dewatering, notify and obtain approval from the local municipality before discharging water to a street gutter or storm drain. Filtration or diversion through a basin, tank, or sediment trap may be required.
- ☐ In areas of known or suspected contamination, call your local agency to determine whether the ground water must be tested. Pumped groundwater may need to be collected and hauled off-site for treatment and proper disposal.

Storm drain polluters may be liable for fines of up to \$10,000 per day!



REVISIONS

d C. Love chitect WILL STREET N BAY, CA 94019

Archite
720 MILL STR
HALF MOON BAY, C

avier Mercado o Ave HMB CA 9401

FOR REVIEW ONLY

DATE: 3/27/2024

SCALE:

DRAWN: AKB

JOB: Mercado


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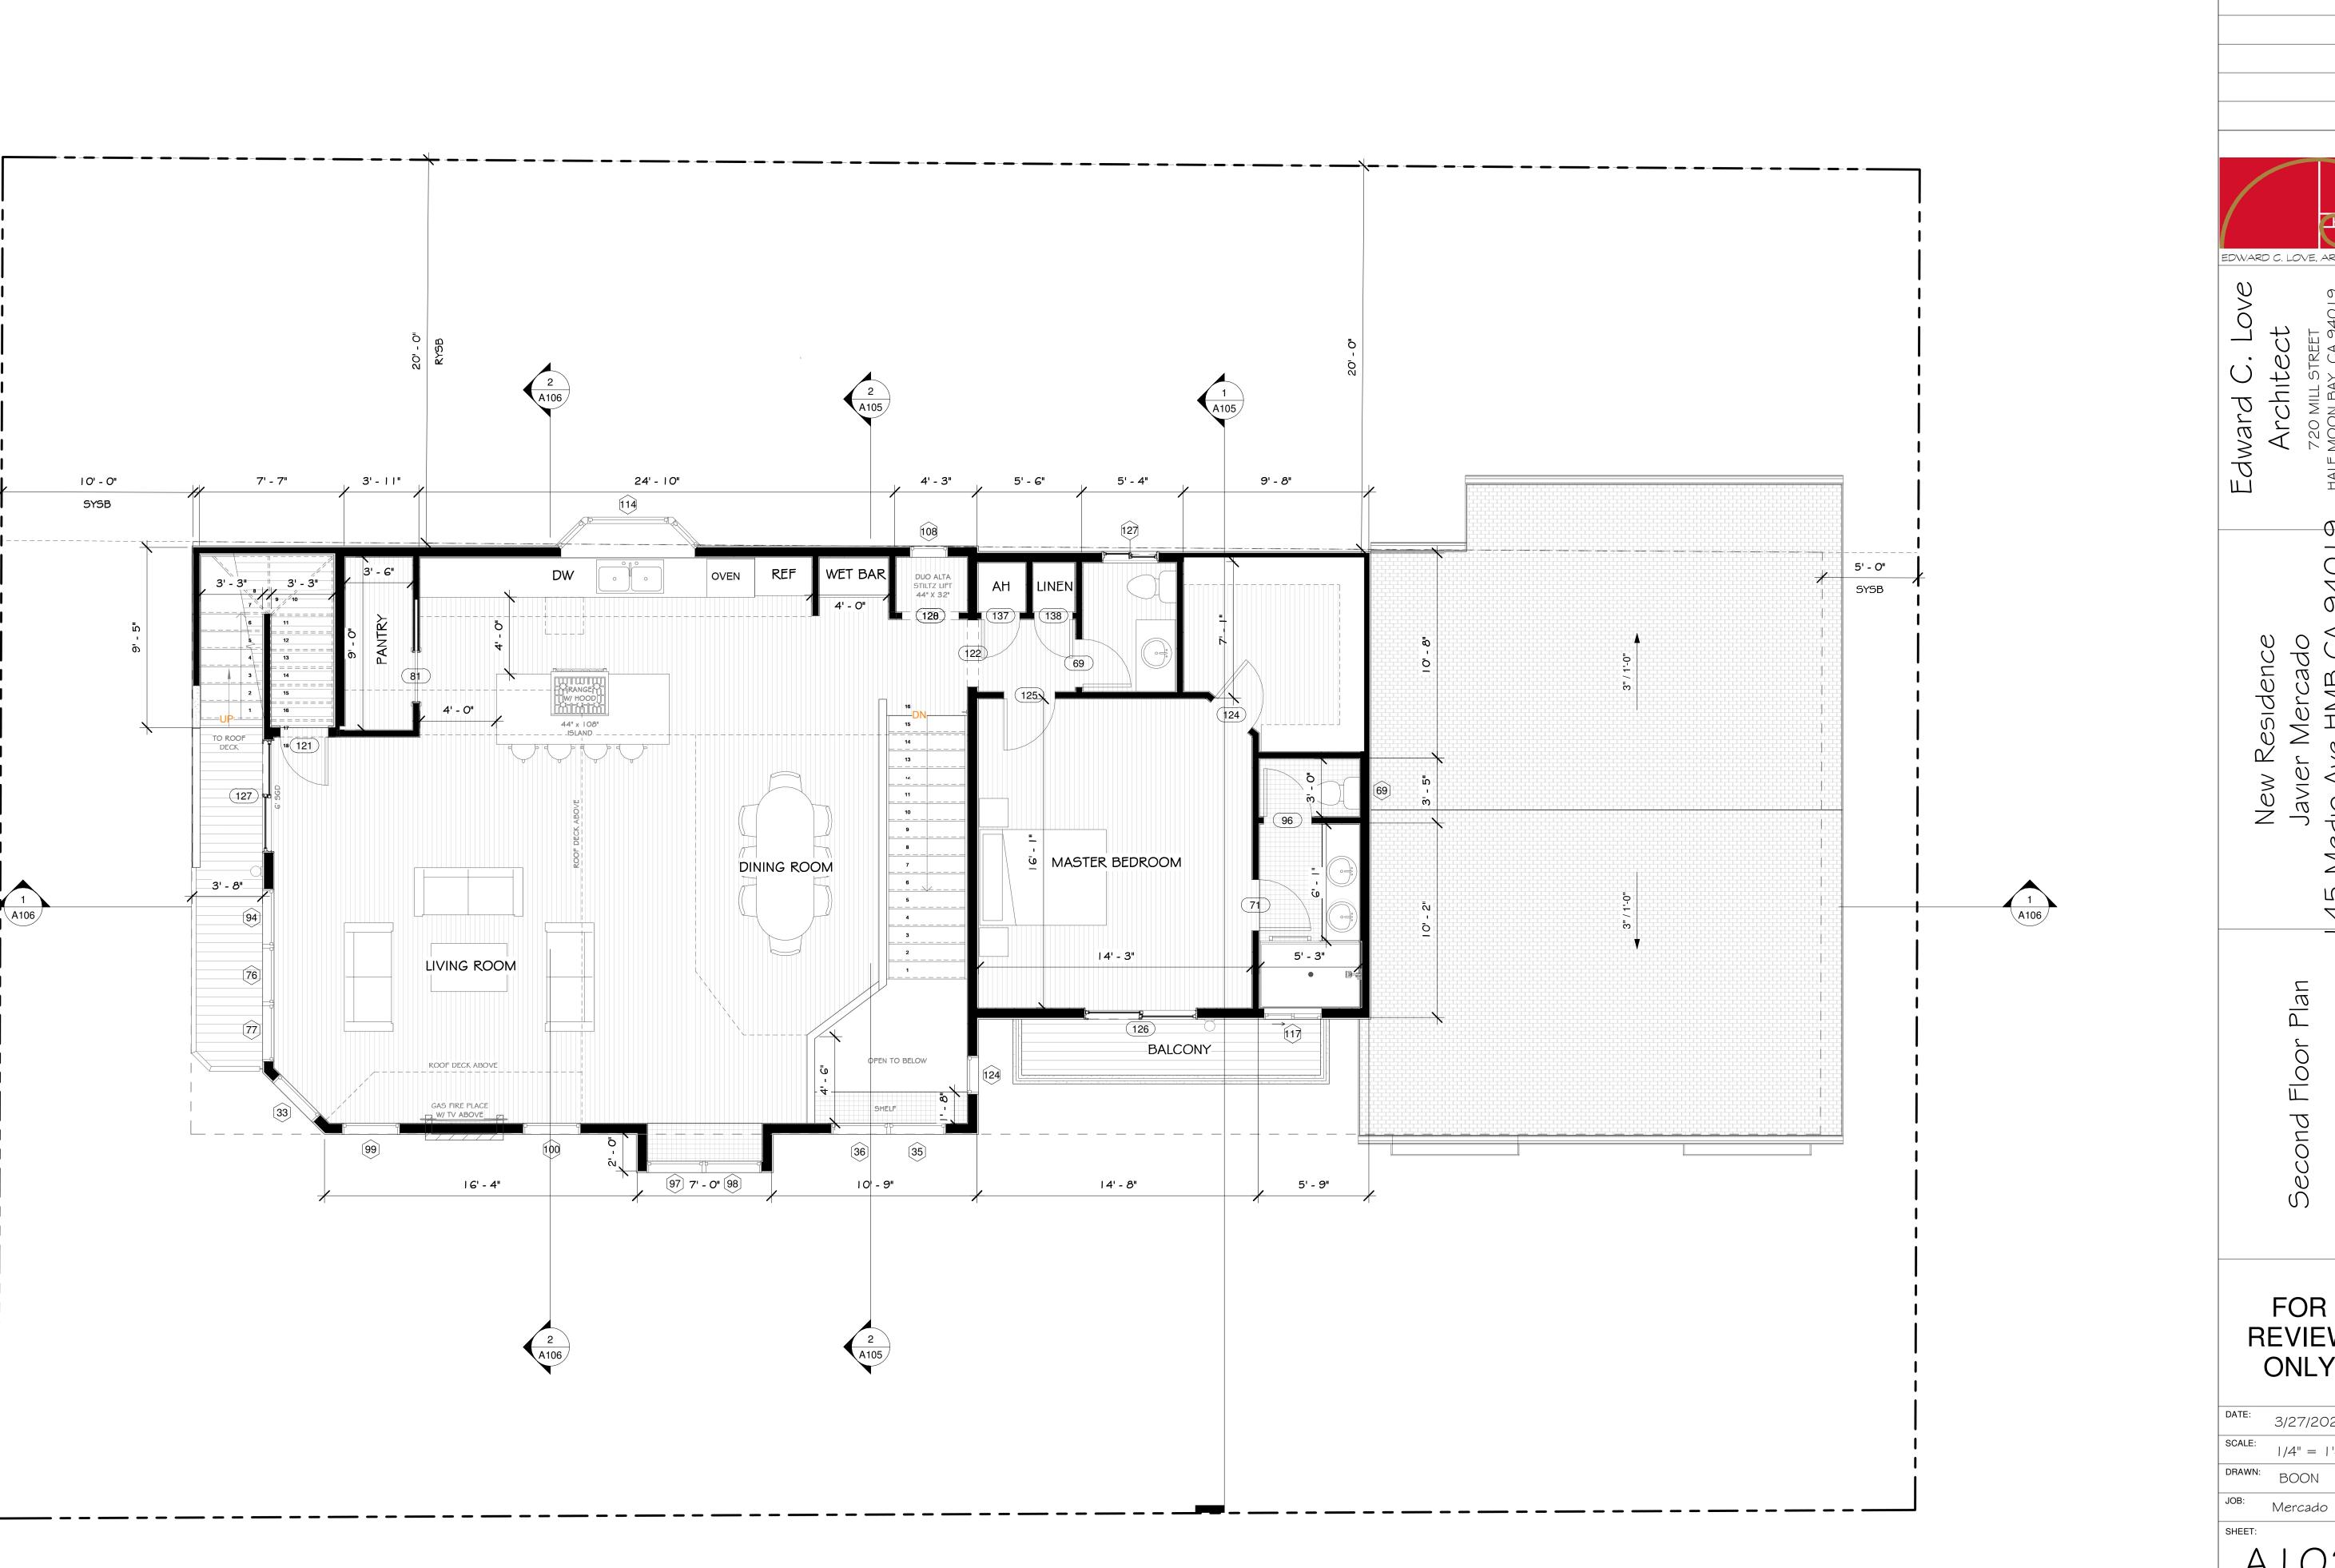
3/27/2024 1/4" = 1'-0" DRAWN:

Mercado

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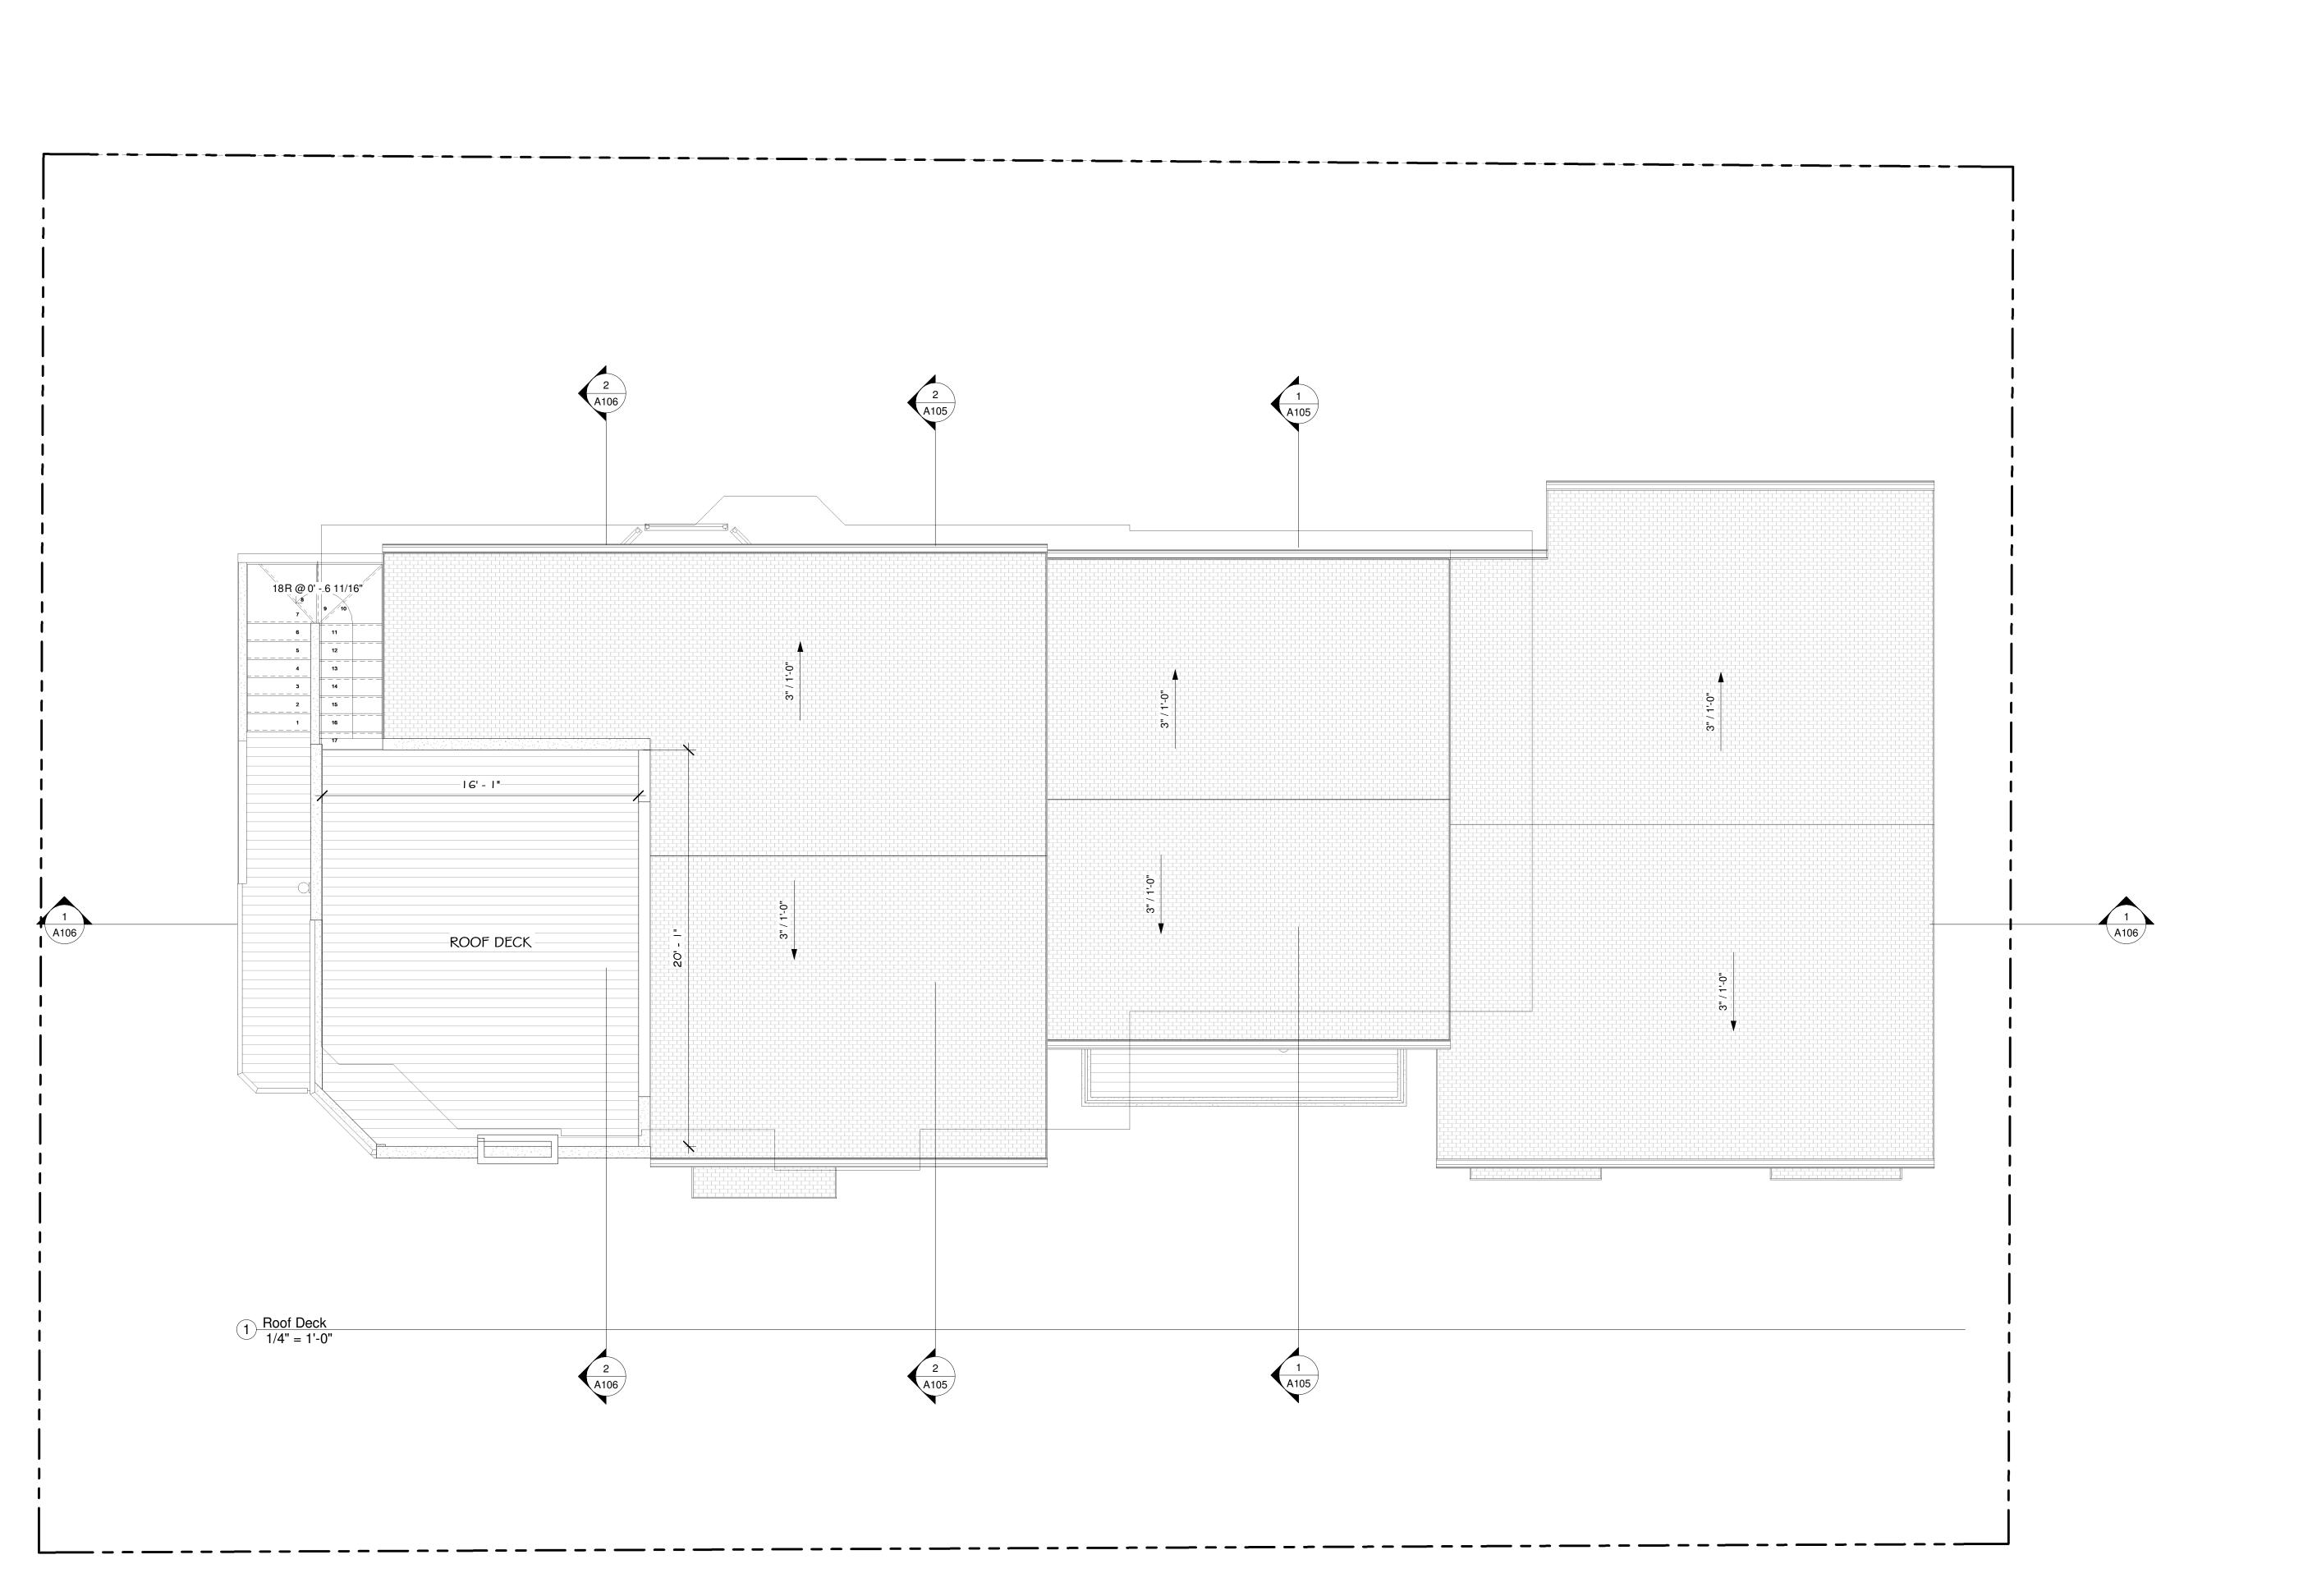
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EDWARD C. LOVE, ARCHITECT

Edward C. Love Architect

> New Residence Javier Mercado Medio Ave HMB CA 94019
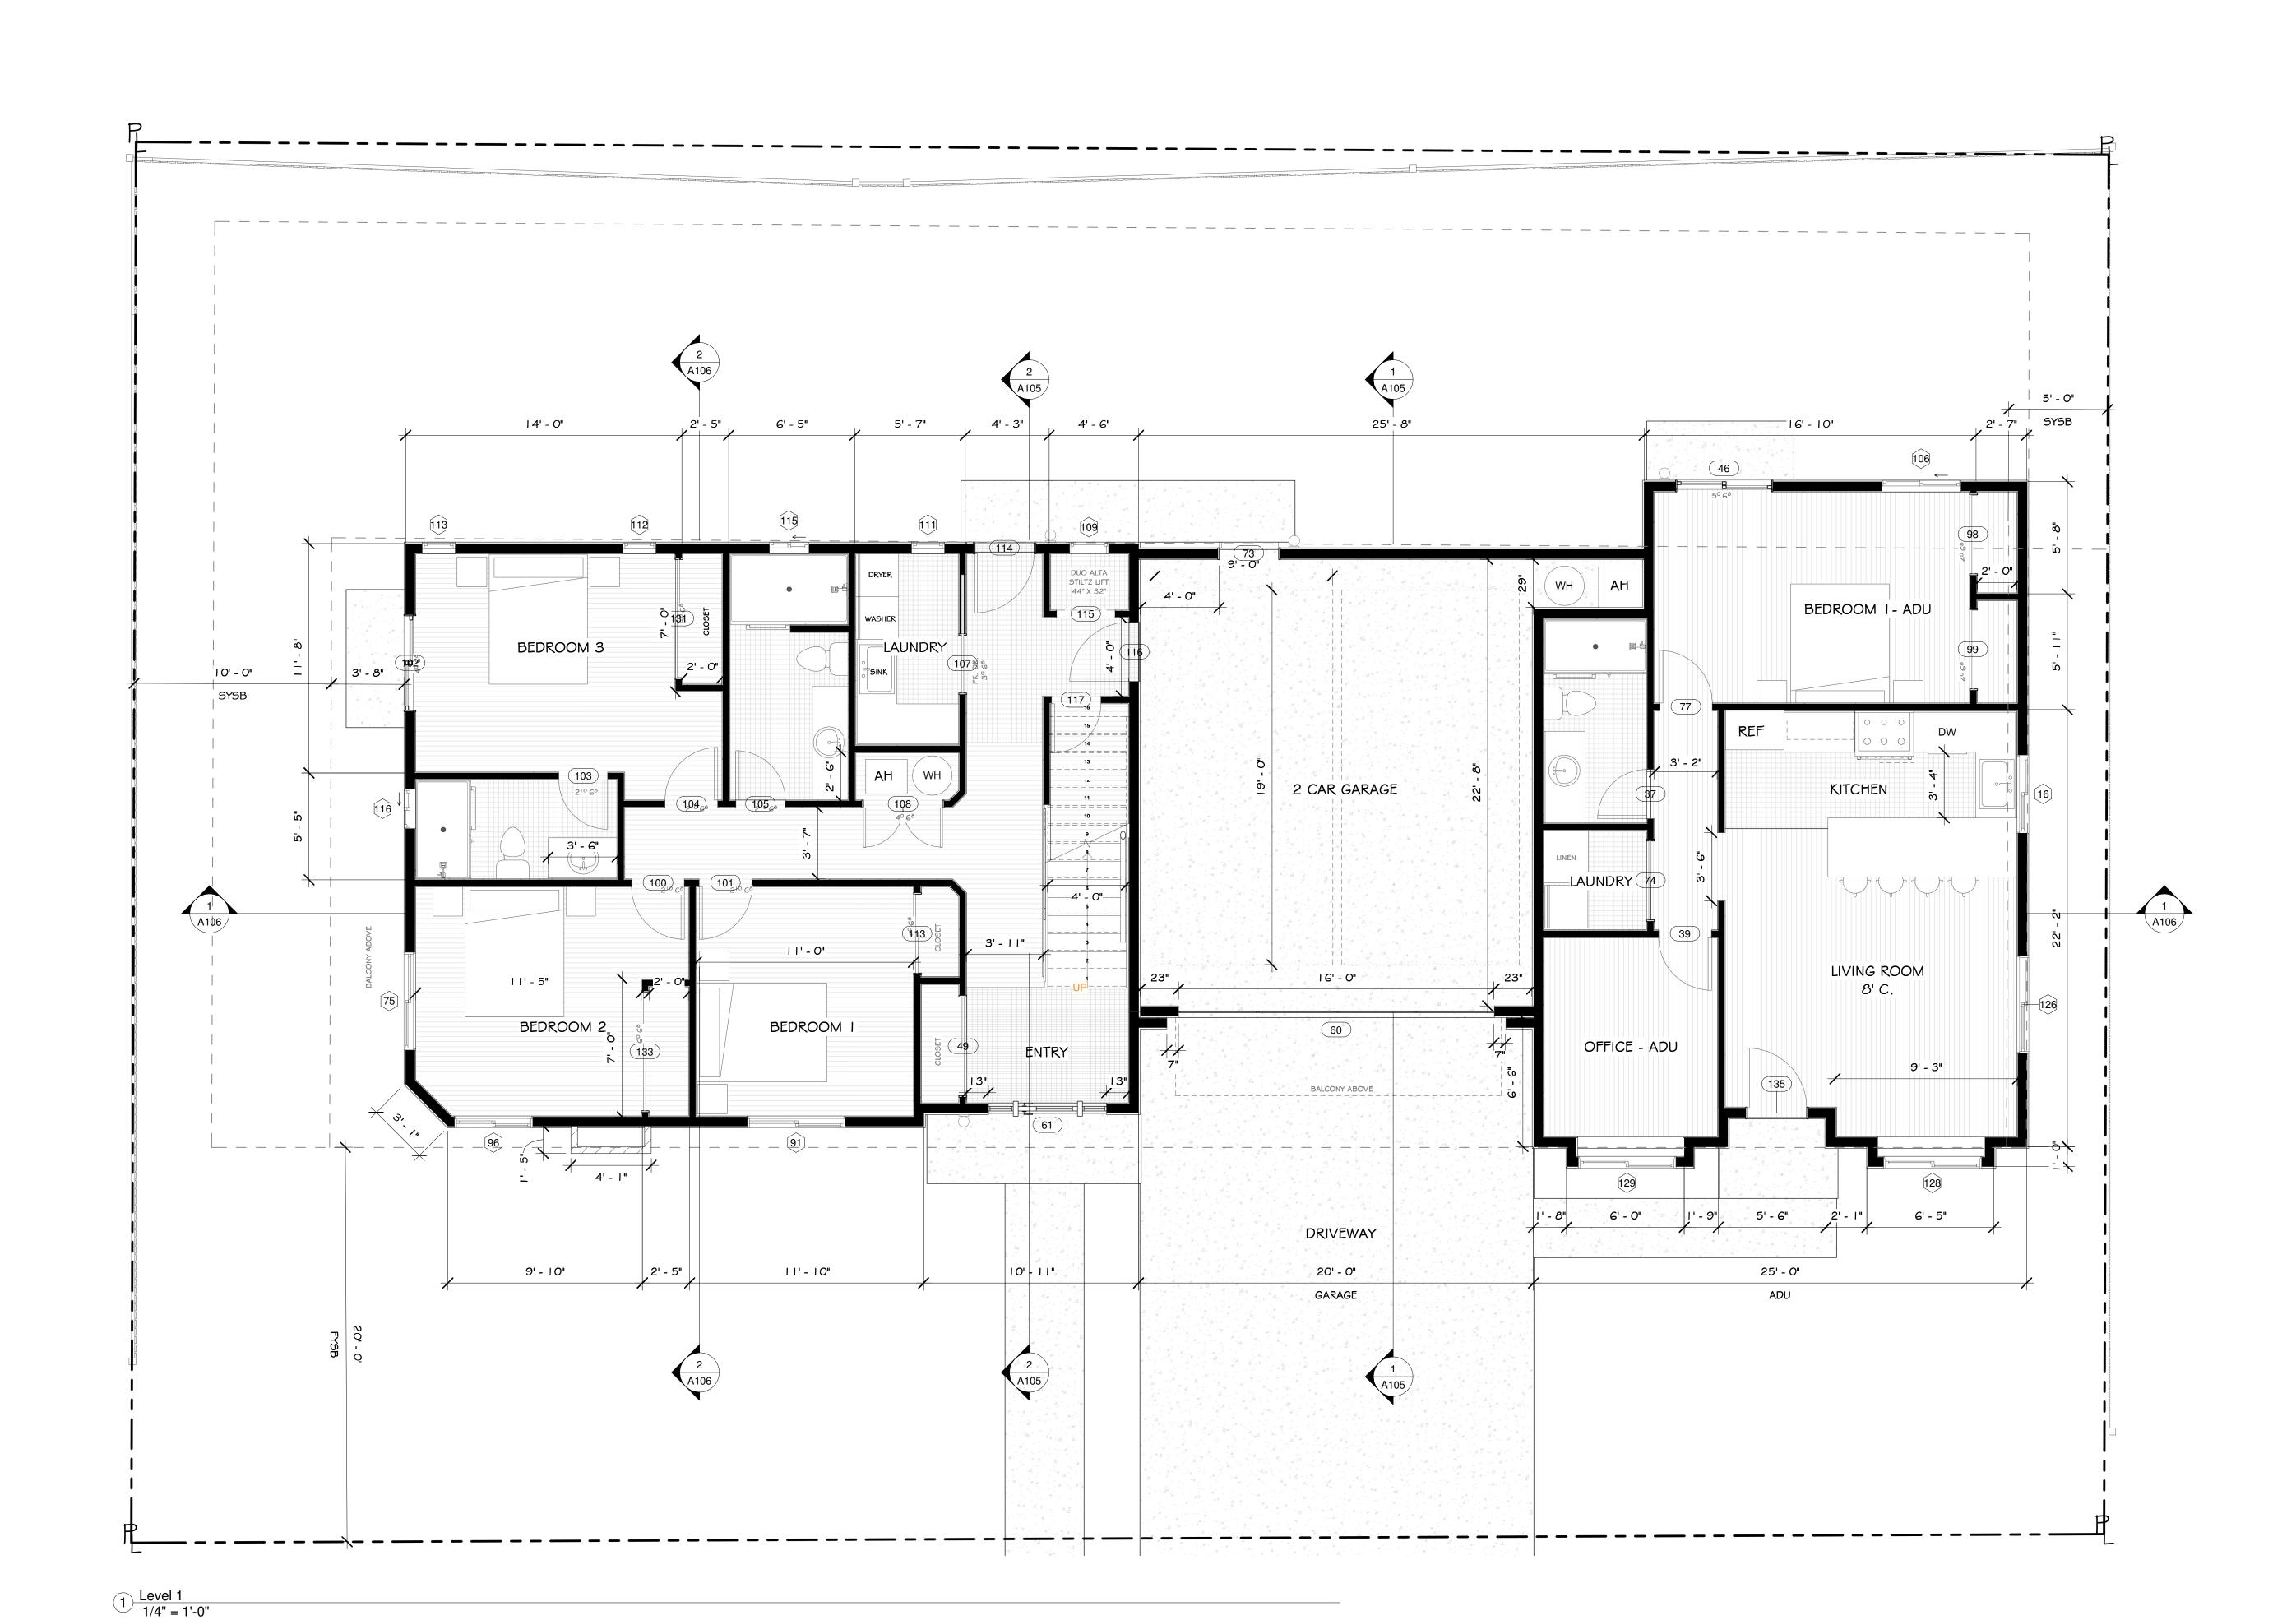
> > Roof Deck

FOR REVIEW ONLY

DATE: 3/27/2024SCALE: 1/4'' = 1'-0''DRAWN: BOON

JOB: Mercado

A 1 0 3

OF

	Door Schedule							
Mark	Туре -	Width	Height	Sıll Height	Tempered Glass -	Comment		
Garage								
60	Garage Door	16' - 0"	7' - 0"	0' - 0 1/2"				
73	Full Lite Exterior	3' - 0"	6' - 8"	0' - 0"	Yes			
	TON LIVE LAVEITOR		0 - 0	0 - 0	103			
Level I 37	Hollow Core Door	2' - 6"	6' - 8"	O' - O"				
		2' - 8"	7' - 0"					
39 46	Hollow Core Door	4' - "	6' - 10"	O' - O"	Vaa			
	Slding Glass Door				Yes			
49	Interior Double Sliding Doors	5' - 0"	6' - 8"	0' - 0"	Yes			
61	Entry	6' - 0"	7' - 0"	0' - 0"				
74	Interior Double Sliding Doors	4' - 0"	6' - 8"	0' - 0"				
77	Hollow Core Door	2' - 8"	7' - 0"	0' - 0"				
98	Interior Double Sliding Doors	4' - 0"	6' - 8"	0' - 0"				
99	Interior Double Sliding Doors	4' - 0"	6' - 8"	O' - O"				
100	Hollow Core Door	2' - 8"	7' - 0"	O' - O"				
101	Hollow Core Door	2' - 8"	7' - 0"	O' - O"				
102	Slding Glass Door	4' - 11"	6' - 10"	0' - 0"	Yes			
103		2' - 6"	7' - 0"	0' - 0"				
104	Hollow Core Door	2' - 8"	7' - 0"	O' - O"				
105	Hollow Core Door	2' - 6"	6' - 8"	O' - O"				
107	Pocket Door	3' - O"	6' - 8"	O' - O"				
108	Interior Double Swing Door	4' - 0"	8' - 0"	0' - 0"				
113	Interior Double Sliding Doors	4' - O"	6' - 8"	O' - O"				
114	Full Lite Exterior	3' - O"	6' - 8"	O' - O"	Yes			
115	Solid Wood Door	O' - O"	O' - O"	O' - O"				
116	Solid Core Door	3' - O"	6' - 8"	O' - O"		20 Min Fire Ratir		
117	Hollow Core Door	2' - 6"	6' - 8"	0' - 0"				
131	Interior Double Sliding Doors	6' - 0"	6' - 8"	0' - 0"				
133	Interior Double Sliding Doors	6' - 0"	6' - 8"	0' - 0"				
135	Full Lite Exterior	3' - O"	6' - 8"	O' - O"				
0								
Level 2 69	Hollow Core Door	2' - 6"	6' - 8"	0' - 0"				
71	Hollow Core Door	2' - 8"	7' - 0"	0' - 0"				
	Hollow Core Door	2' - 8"	6' - 8"	0' - 0"				
<u>81</u> 96	Hollow Core Door	2' - 6"	6' - 8"	0' - 0"				
120	Solid Wood Door	0' - 0"	0' - 0"	0' - 0"				
		2' - 6"	6' - 8"	0' - 0"				
121	Hollow Core Door	0' - 0"	0' - 0"	0' - 0"				
122	Door Opening							
124	Hollow Core Door	2' - 6"	6' - 8"	0' - 0"				
125	Hollow Core Door	2' - 8"	7' - 0"	0' - 0"				
126	Slding Glass Door	5' - 11"	6' - 10"	0' - 0"	Yes			
127	Slding Glass Door	5' - 11"	6' - 10"	0' - 0"	Yes			
128	Solid Wood Door	0' - 0"	0' - 0"	0' - 0"				
137	Hollow Core Door	2' - O"	6' - 8"	O' - O"				
138	Hollow Core Door	2' - 0"	6' - 8"	O' - O"				

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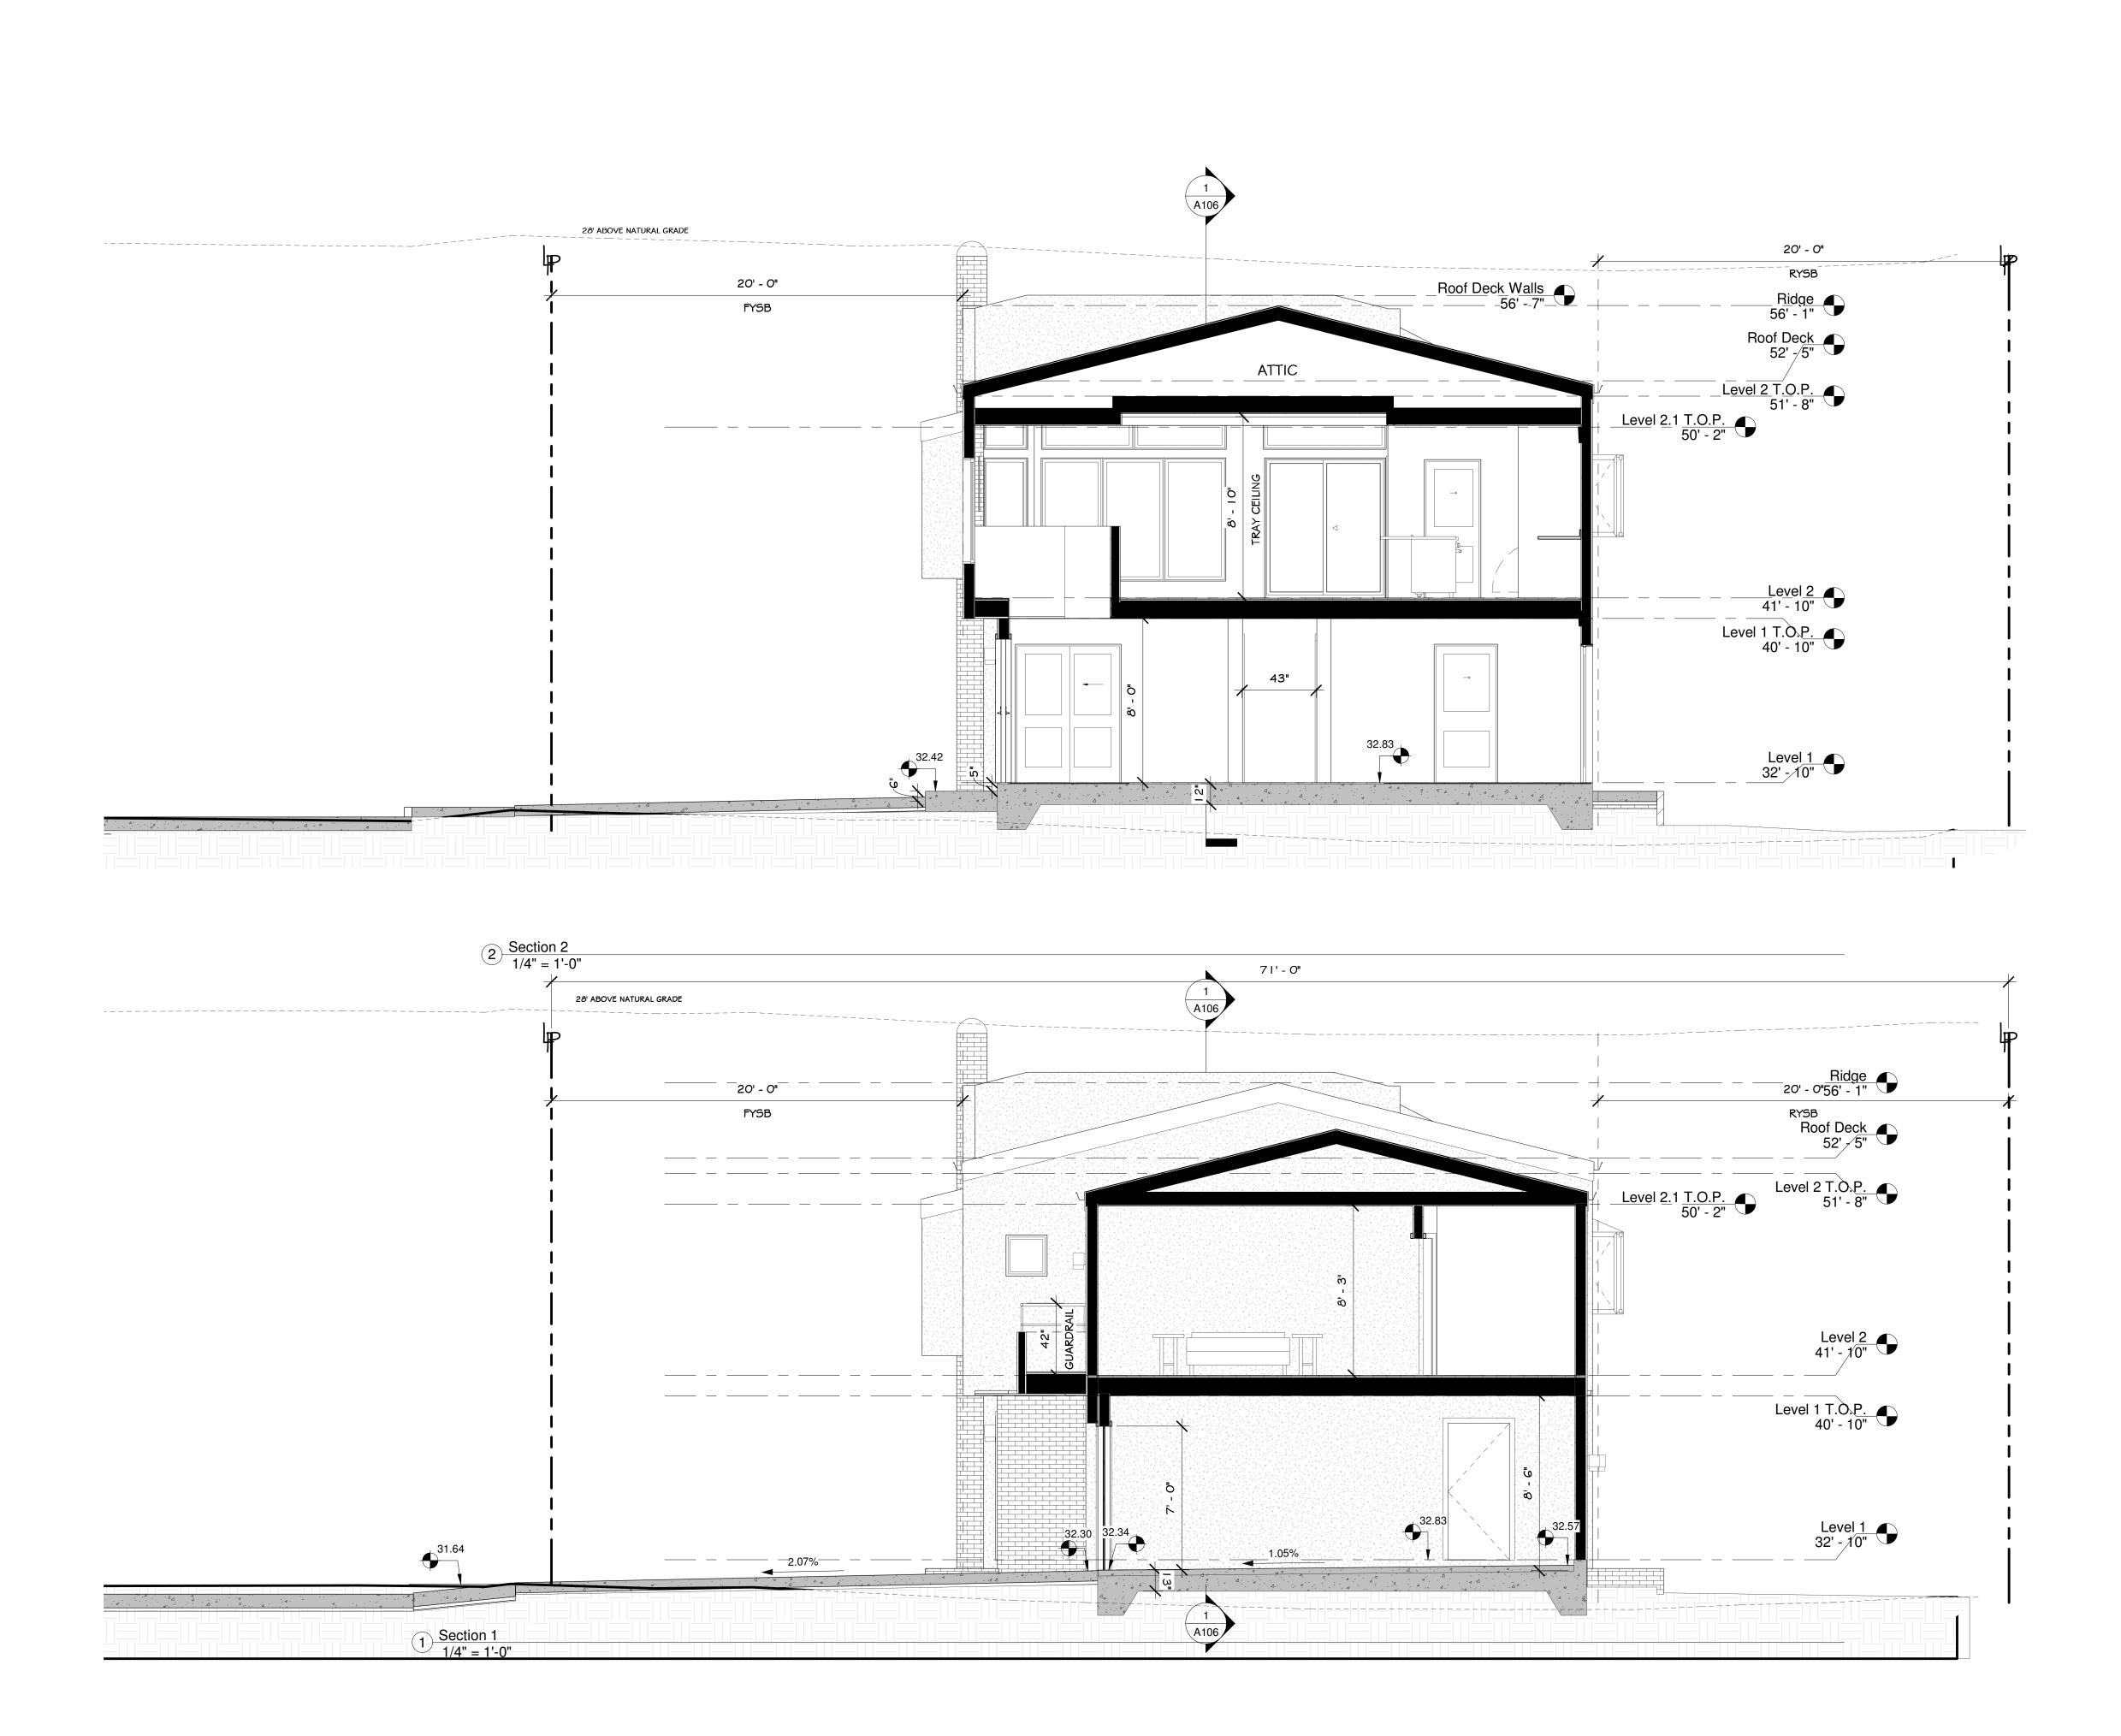
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JOB: Mercado

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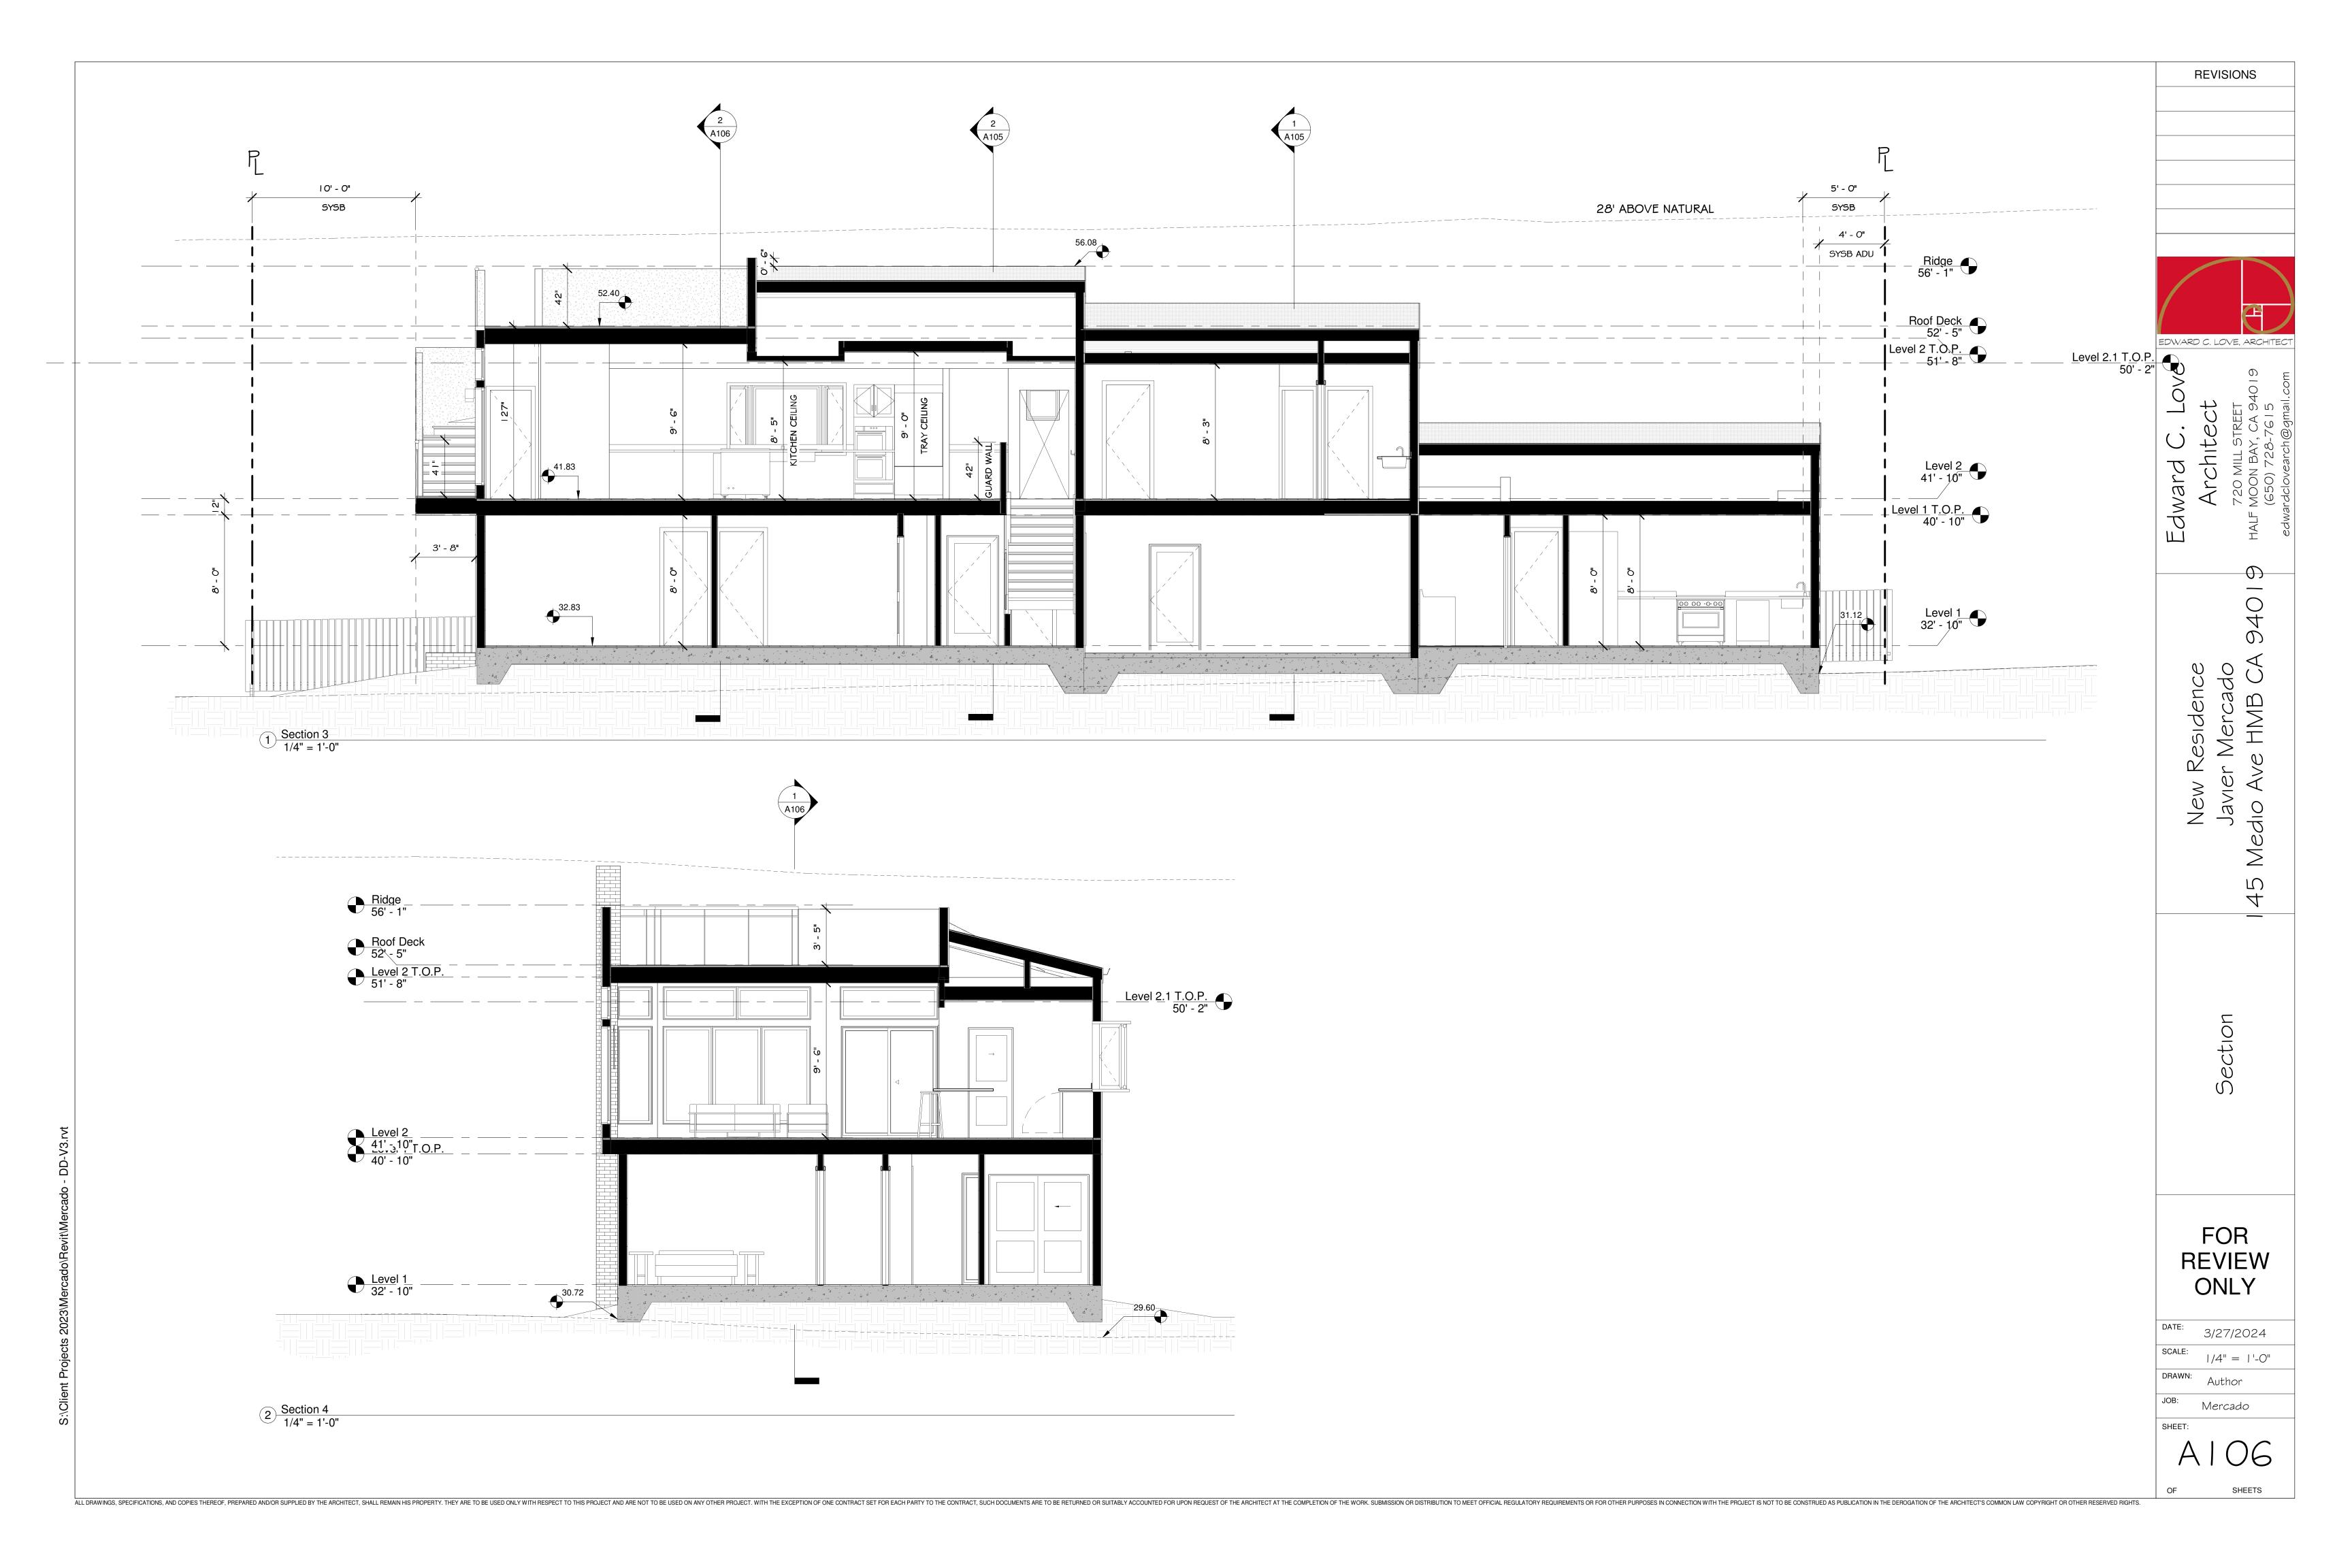
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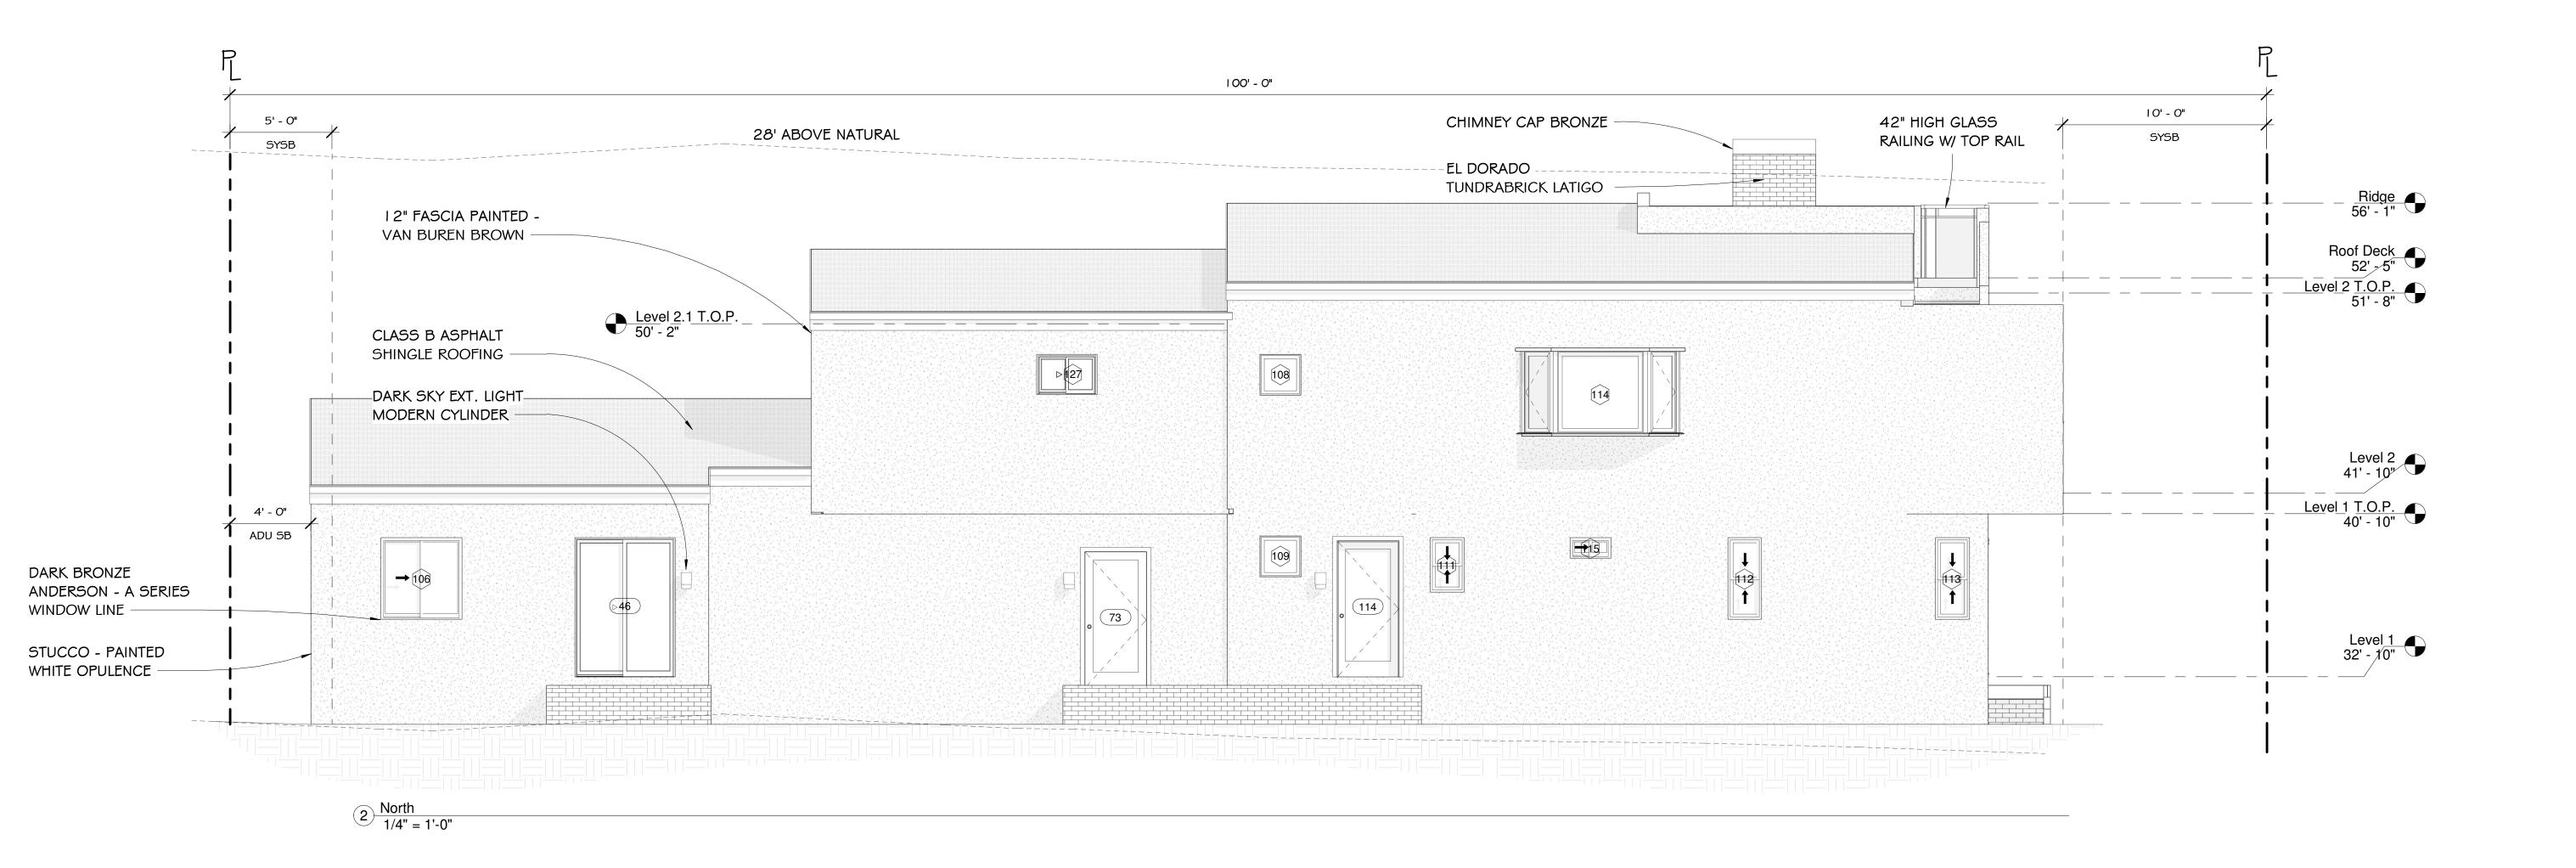
DATE: 3/27/2024SCALE: 1/4'' = 1'-0''DRAWN: AKB

JOB: Mercado

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Elevations

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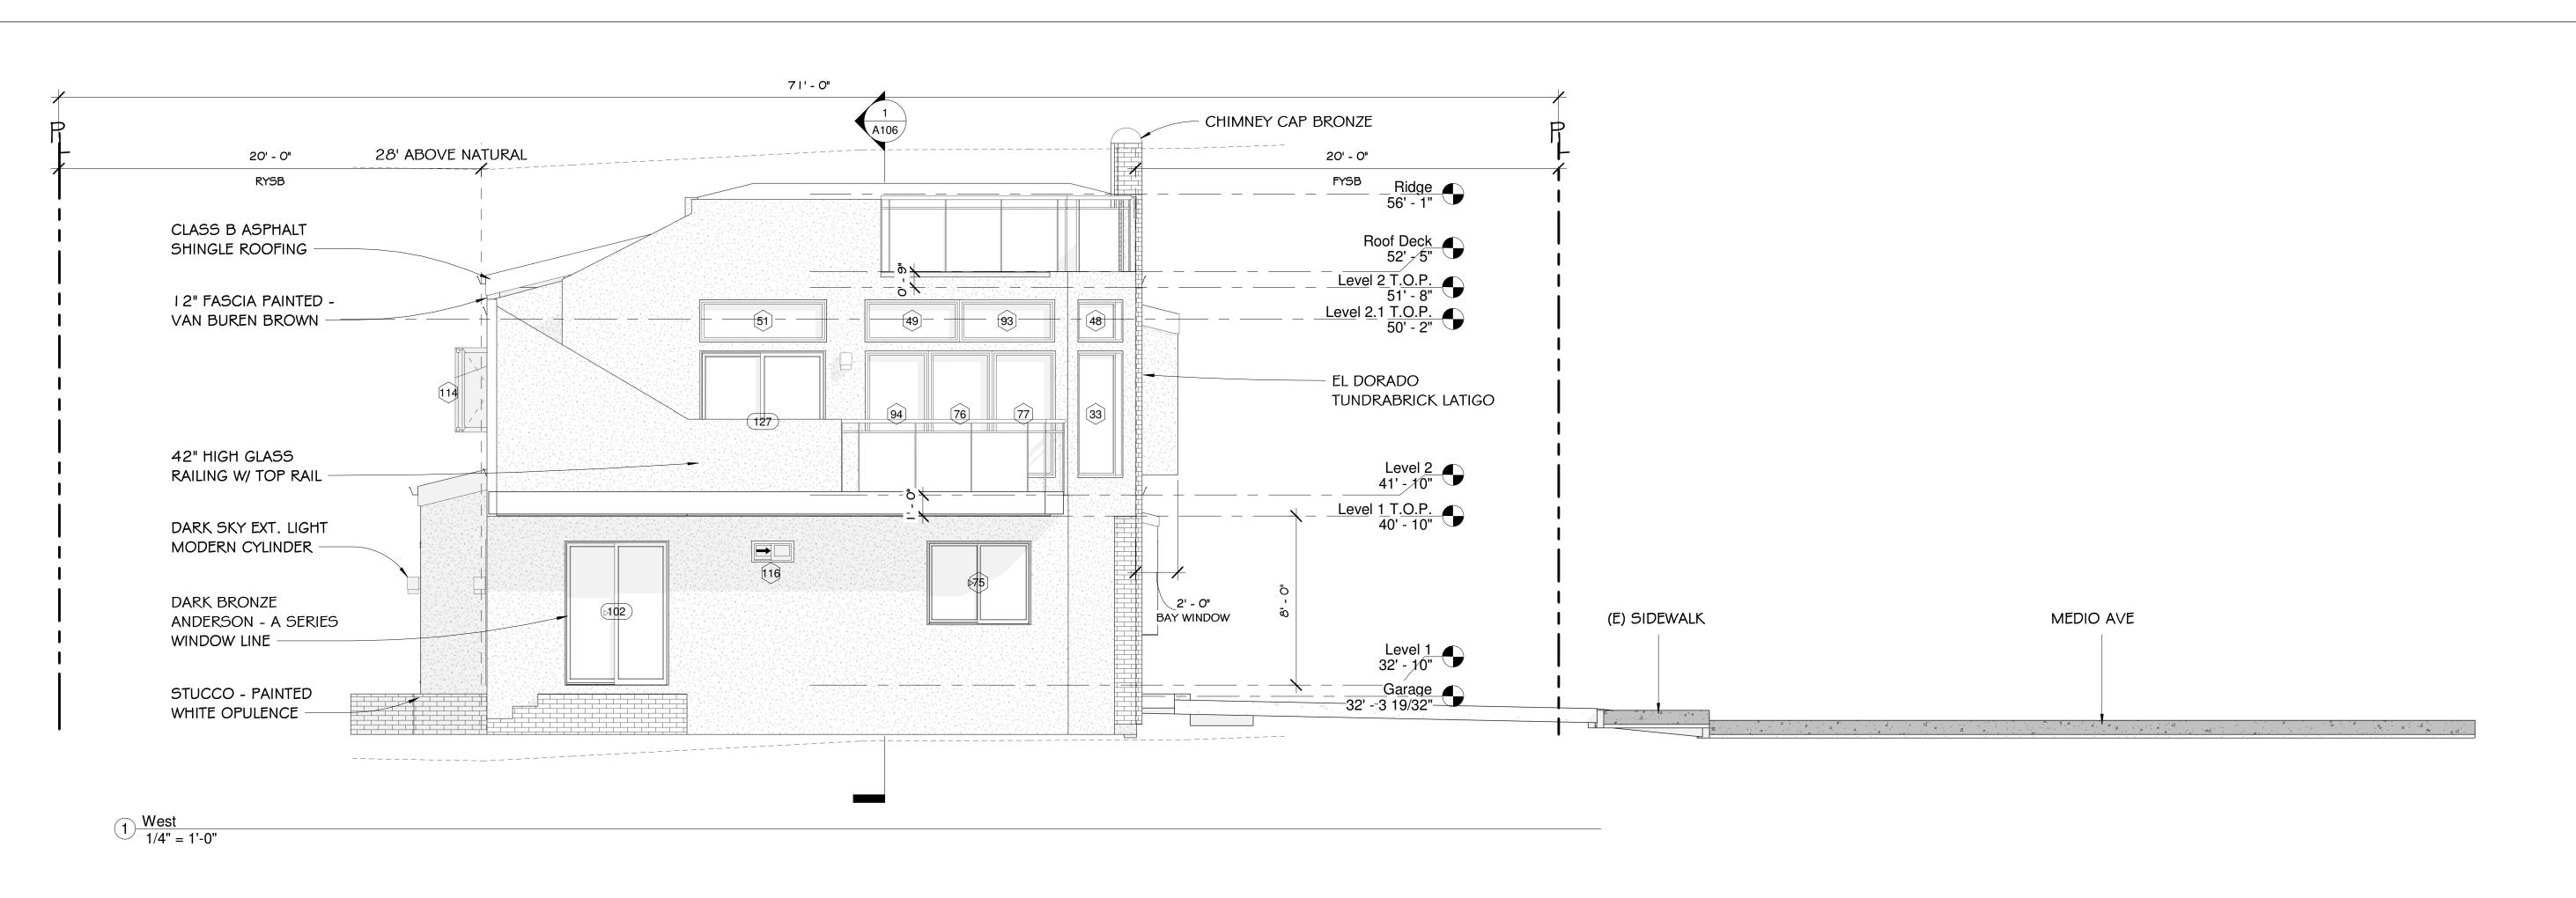
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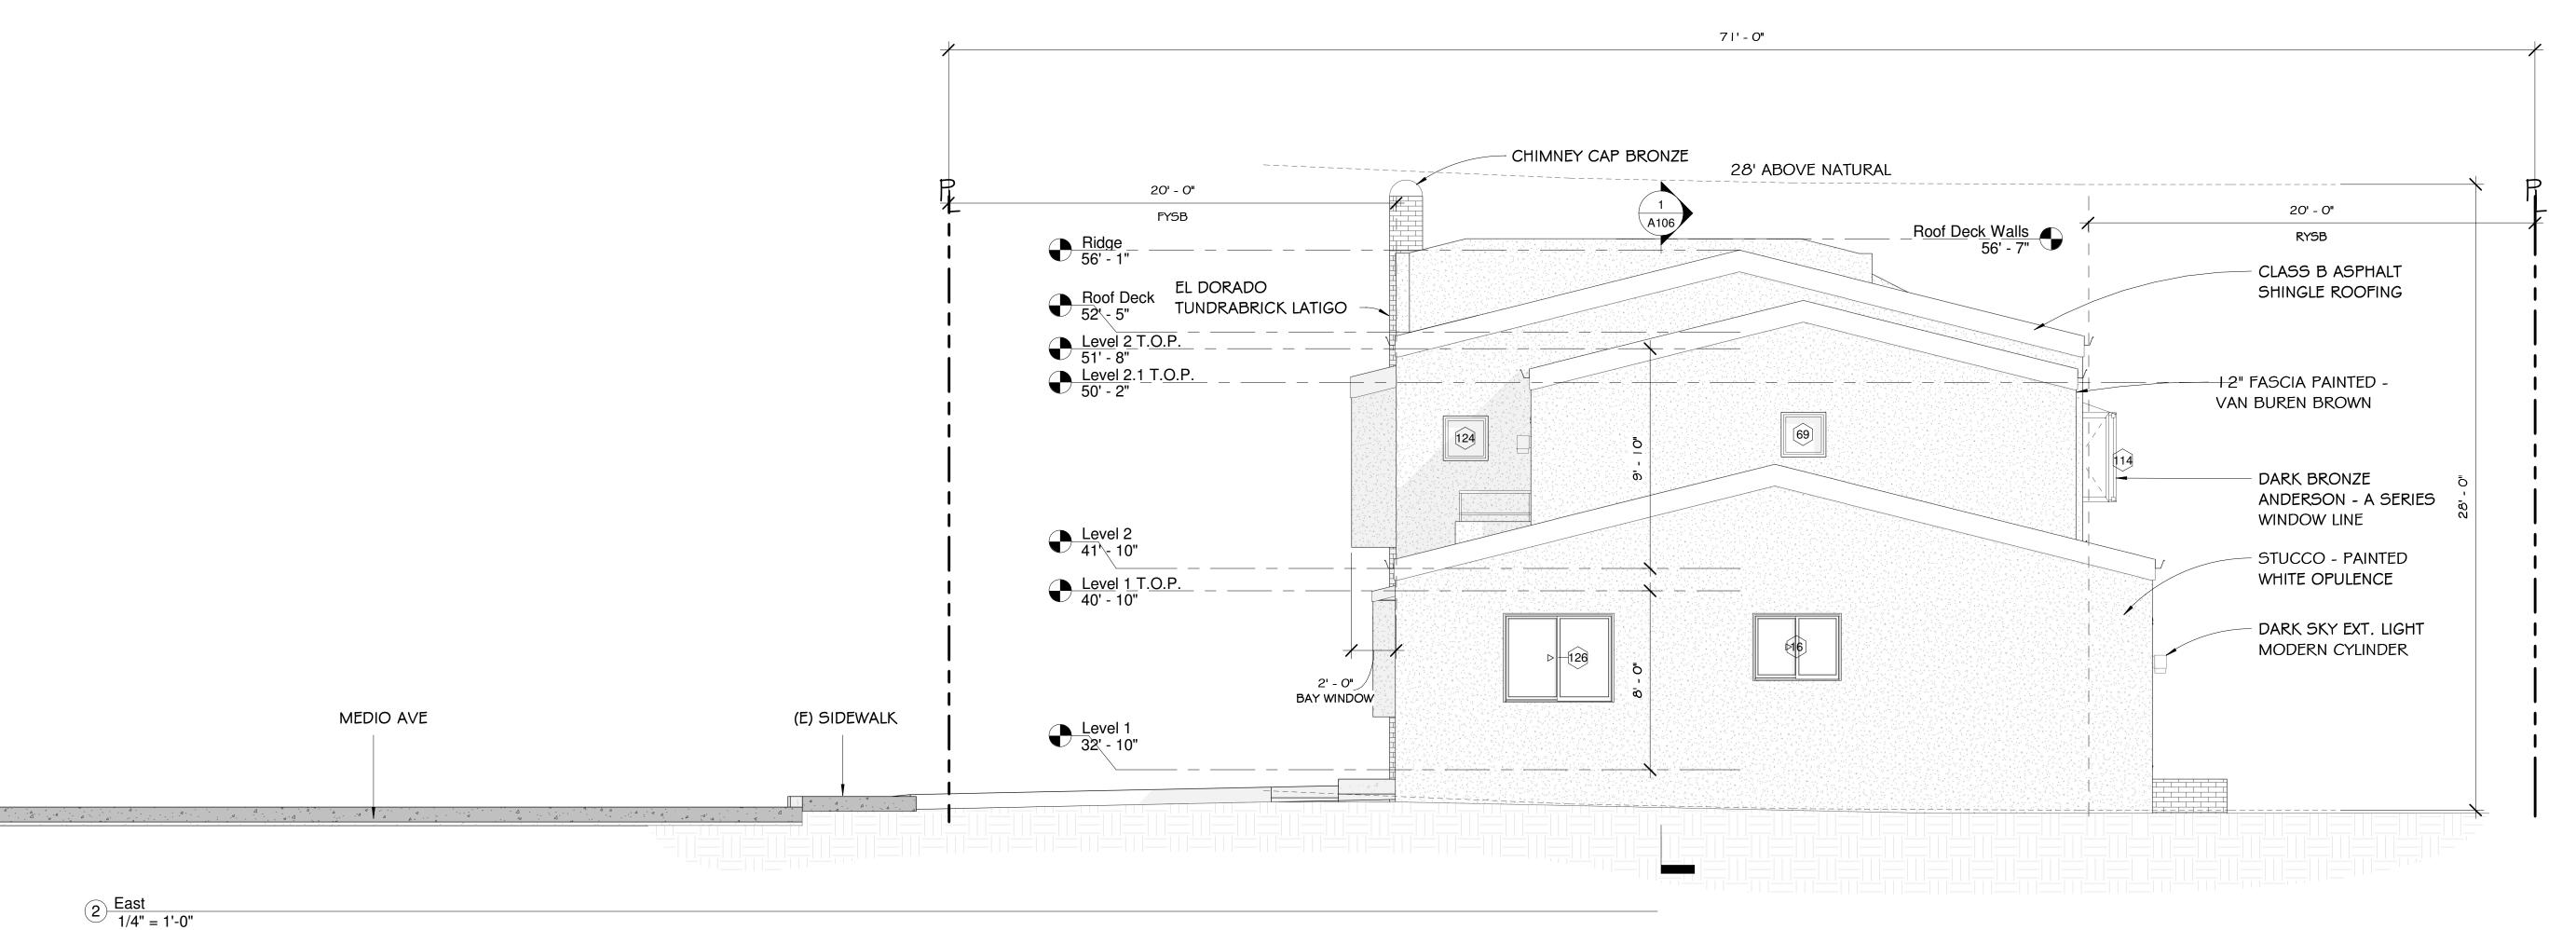
SCALE: 1/4" = 1'-0"

DRAWN: BOON

JOB: NA

Mercado
SHEET:





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3/27/2024

1/4" = 1'-0"

Mercado


A202

SHEETS

DRAWN:

REVISIONS

Client Projects 2023/Mercado/Bevit/Mercado - DD-

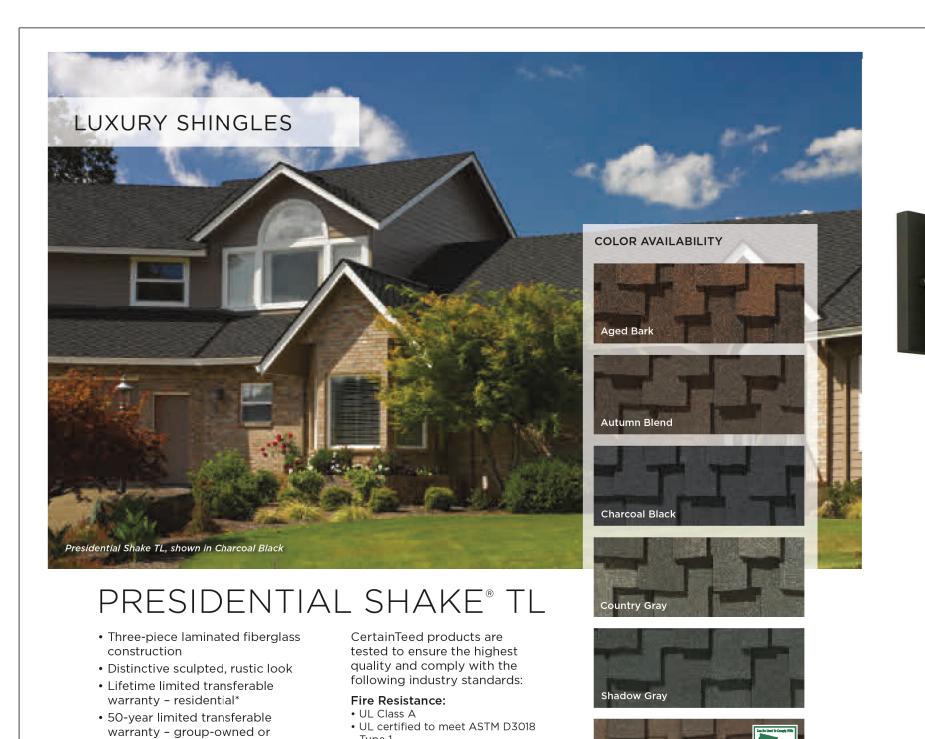

<u>Product Overview</u>

The outdoor LED wall lantern is uniquely designed with a contemporary feel. Its durable aluminum construction with hand painted black finish and frosted glass gives a sophisticated look.

This uniquely designed fixture is the choice of discriminating yet value conscious homeowners who want to enrich their home.

Darksky certified

Light color is 3000K (bright white) 360 Lumens 80 CRI and uses only 5.5-Watt

Specifications

Dimensions

Product Depth (in.) 5.91 Product Height (in.) 8.01 Product Length (in.) 8.01 Product Width (in.) 4.49

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Details

Actual Color Temperature (K) 3000 Color Rendering Index 80

Color Temperature Bright White

Exterior Lighting Product Type Cylinder Lights Fixture Color/Finish Black
Fixture Material Aluminum Glass/Lens Type Frosted

Light Bulb Type Included Integrated LED Light Output (lumens) 360

Maximum Wattage (watts) 0 Number of Bulbs Required 0

Watt Equivalence 60

Outdoor Lighting Features Dark Sky, Weather Resistant, Weather Resistant

Power Type Hardwired
Product Weight (lb.) 2.29lb

Style Modern

ENTRE/MATIC

Solaris Charcoal Black CRRC Product ID 0668-0132

Amarr[®] Vista VI1000

commercial*

warranty

• 15-year StreakFighter® algae-resistance

warranty (where available)
• 10-year SureStart™ protection

• 15-year 110 mph wind-resistance

Wind warranty upgrade to 130 mph

available. CertainTeed starter and

CertainTeed hip and ridge required

and ridge accessory available (see

details in back of brochure)

Select colors can be used

to comply with the 2019

California Title 24 Part 6 Cool Roof Requirements

 Colors marked with * can be used to comply with Los Angeles County, California Title 31 cool roof

residential construction.

requirements for steep-sloped

* See warranty for specific details and limitations.

• Presidential Starter (required) and hip Acceptance: Please reference

Contemporary Aluminum Full View Garage Doors

Wind Resistance:

ASTM D3161 Class A

CSA standard A123.5

Quality Standards:

Tear Resistance:

• UL certified to meet ASTM D3018

• UL certified to meet ASTM D3462

Wind Driven Rain Resistance:

determine approved products

by manufacturing location.


• ICC-ES-ESR-1389 & ESR-3537


Miami-Dade Product Control

www.certainteed.com to





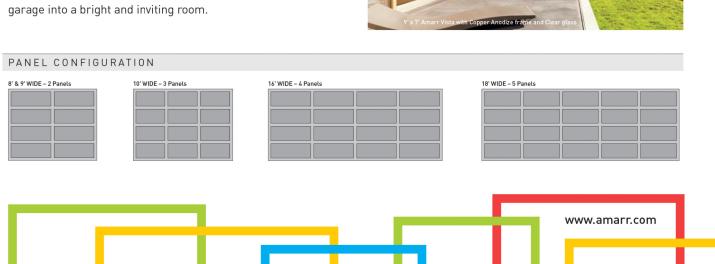

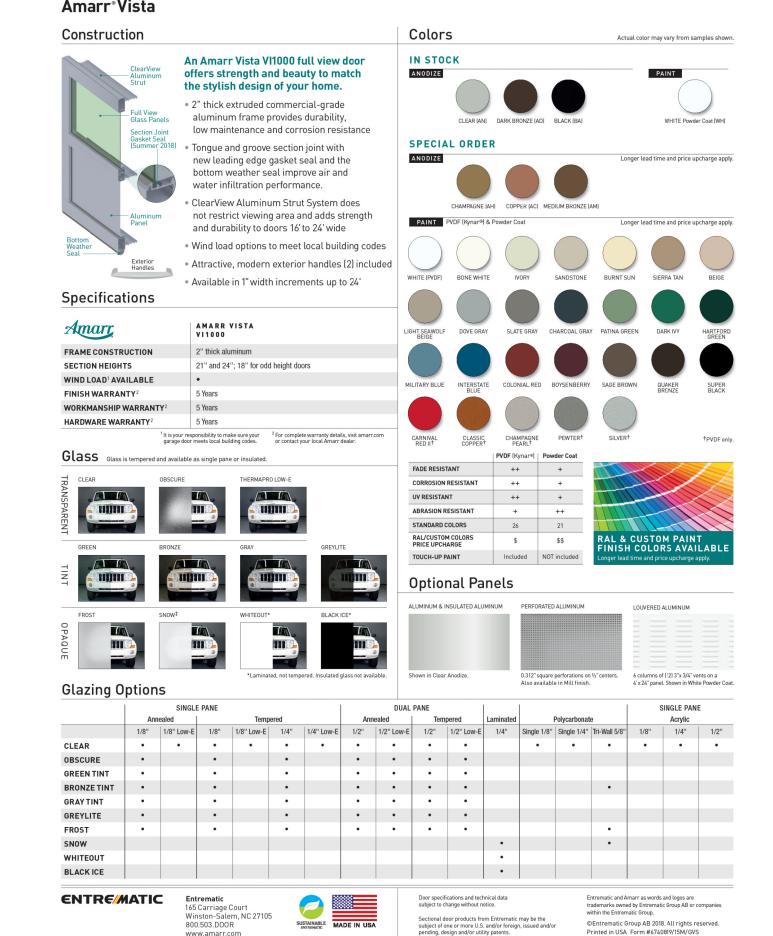

EDWARD C. LOVE, ARCHITECT SCALE: DRAWN: Mercado

SHEETS

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SEE STRUCTURAL PLANS FOR MATERIALS, DIMENSIONS & DETAILS

BENJAMIN MOORE

STUCCO PAINTED

VAN BUREN BROWN HC-70


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1 Material Sheet 1/4" = 1'-0"



EL DORADO BRICK -LATIGO




CERTAIN TEED SAINT-GOBAIN LUXURY SHINGLES - PRESIDENTIAL SHAKE TL AUTUMN BLEND

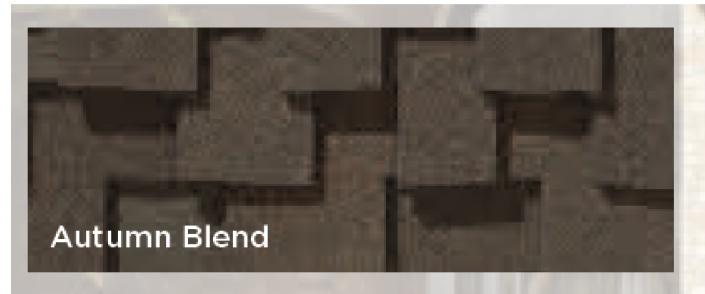

STUCCO PAINTED WHITE OPULENCE OC-69

BENJAMIN MOORE

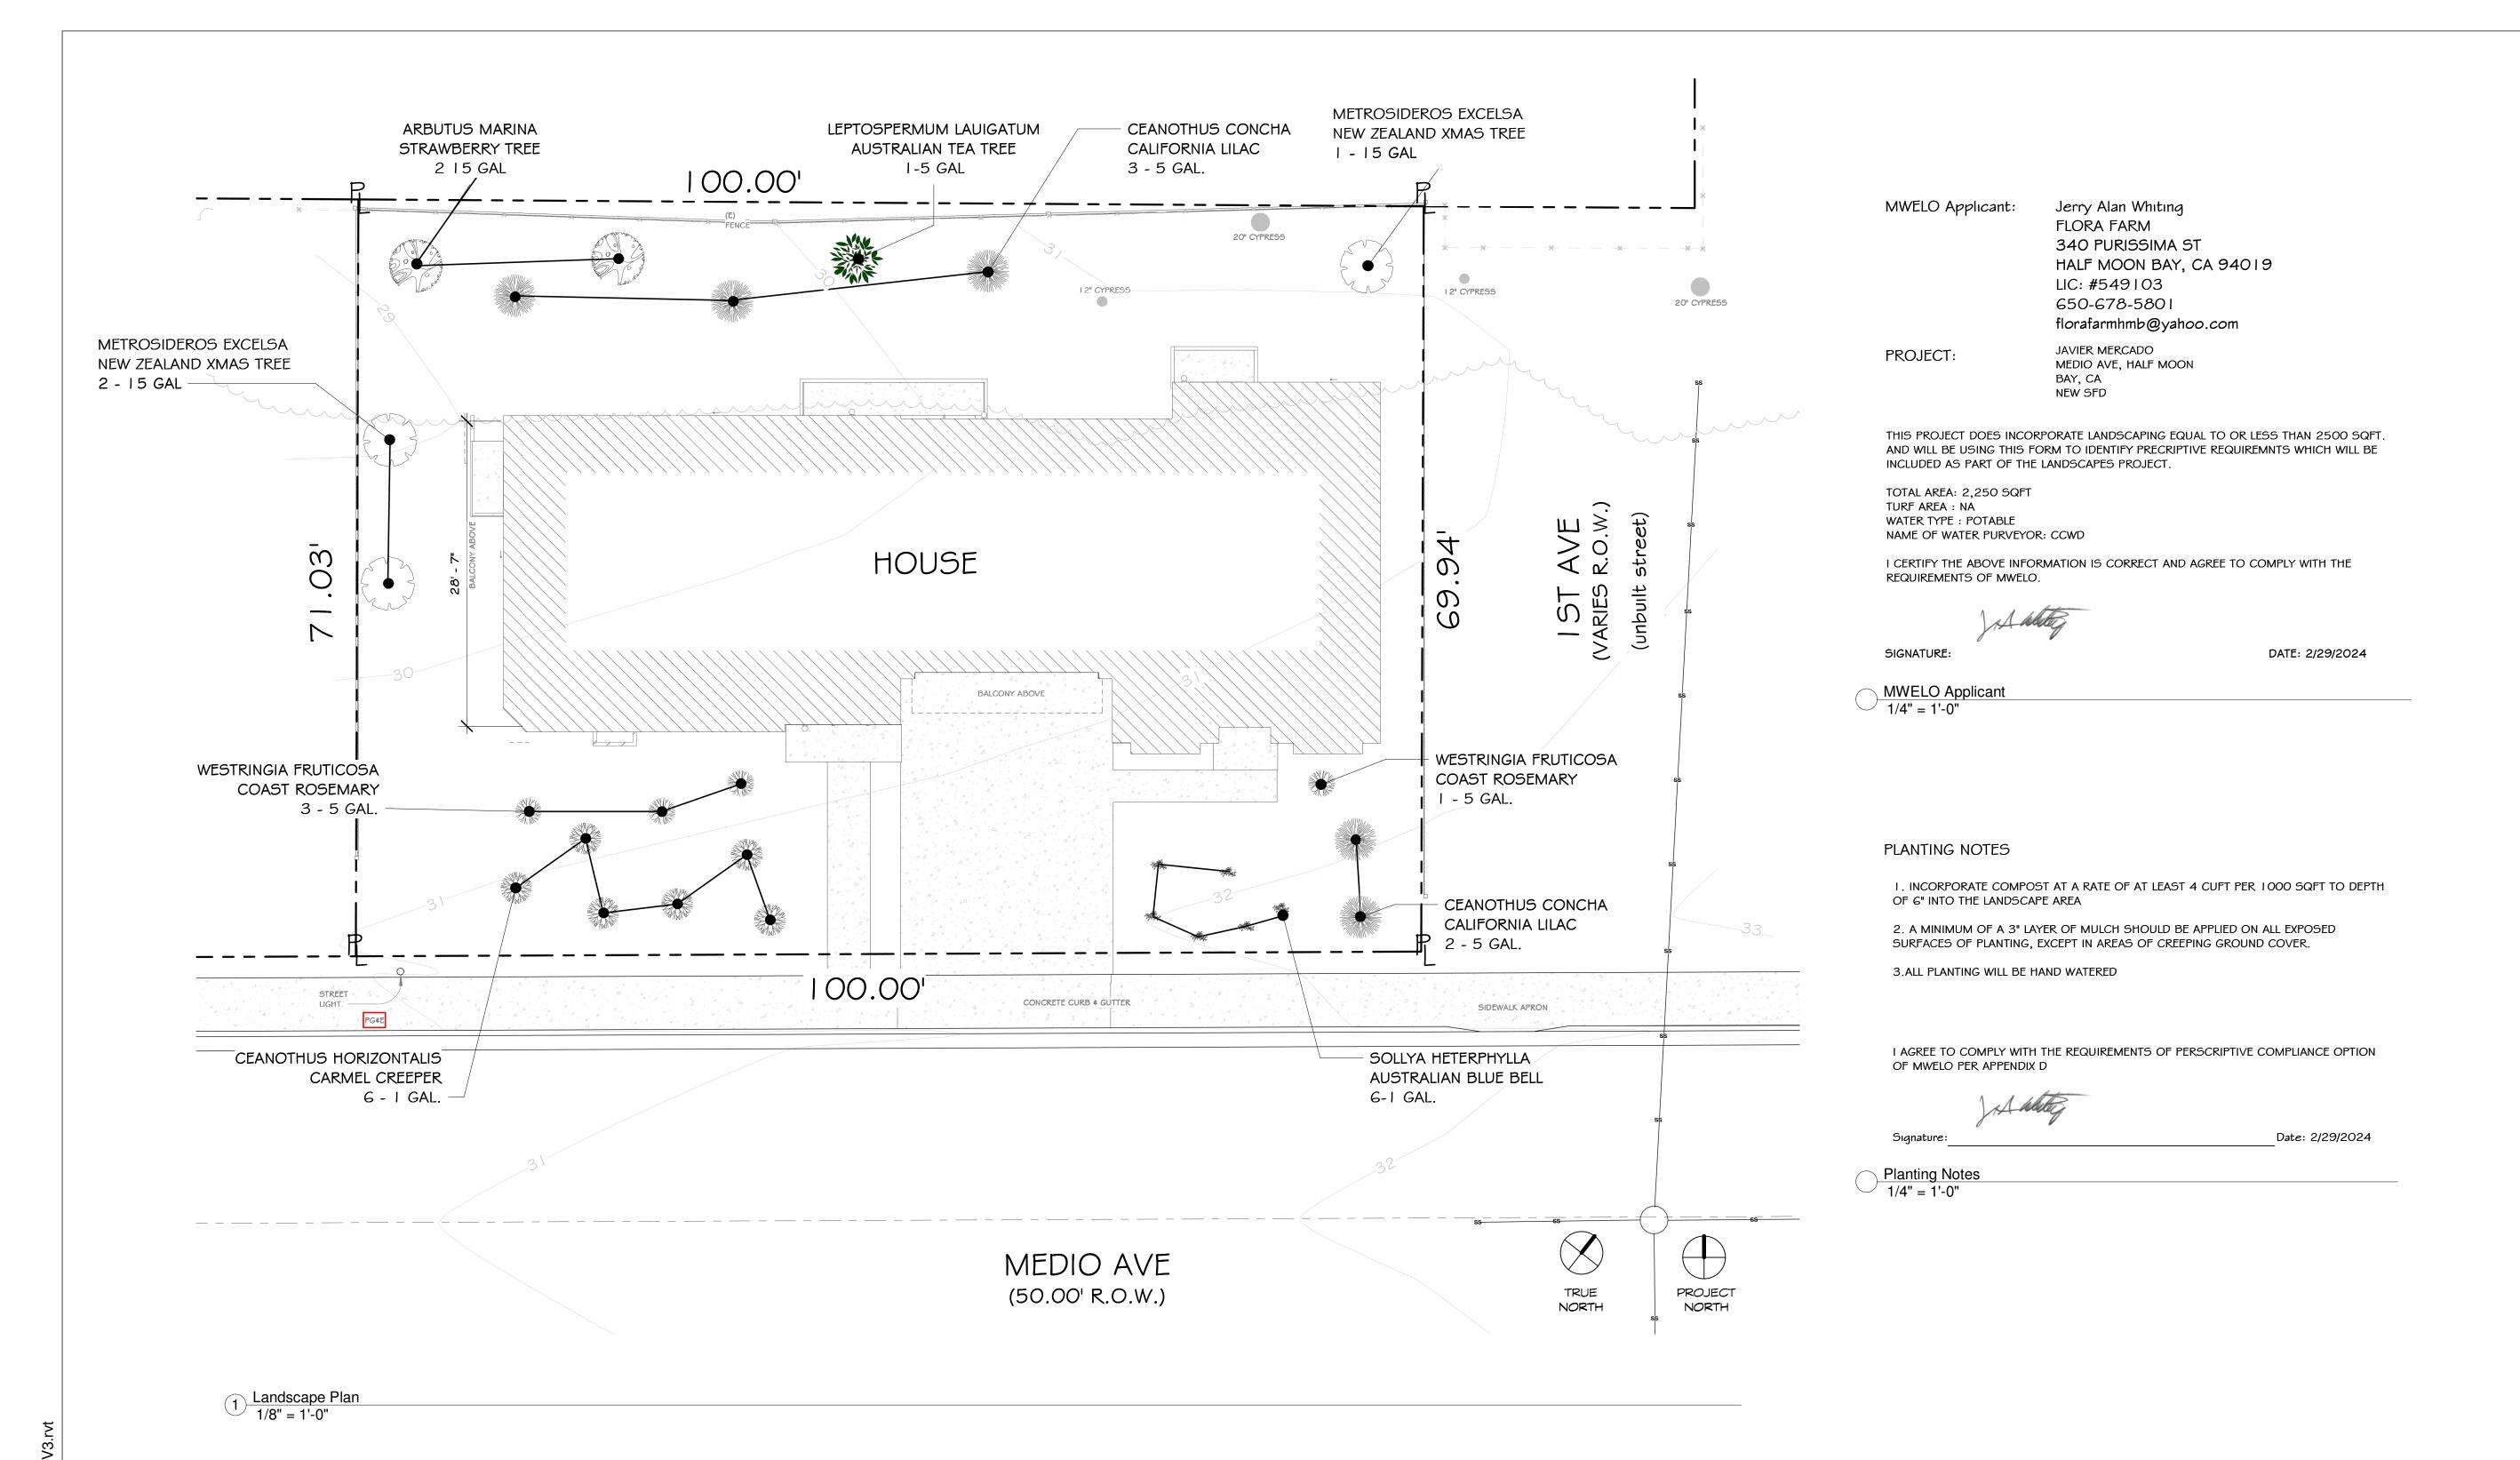

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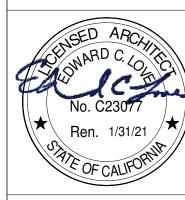
BOTINICAL NAME COMMON NAME QTY. SIZE TYPE ARBUTUS MARINA STRAWBERRY TREE 15 GAL. TREE METROSIDEROS EXCELSA NEW ZEALAND XMAS TREE 15 GAL. TREE CEANOTHUS HORIZONTALIS CARMEL CREEPER GR. COVER WESTRINGIA FRUTICOSA COAST ROSEMARY 5 GAL. SHRUB AUSTRALIAN TEA TREE 5 GAL. SHRUB LEPTOSPERMUM LAUIGATUM SOLLYA HETERPHYLLA AUSTRALIAN BLUE BELL CEANOTHUS CONCHA CALIFORNIA LILAC 5 GAL. SHRUB

 $\frac{\text{Plant List}}{1/4" = 1'-0"}$

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REVISIONS

New Residence Javier Mercado



SCALE: As indicated

DRAWN: Author

JOB: Mercado

SHEET:

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